
BUILDING 1830 REMODEL

CAMP WILLIAMS
UTAH NATIONAL GUARD

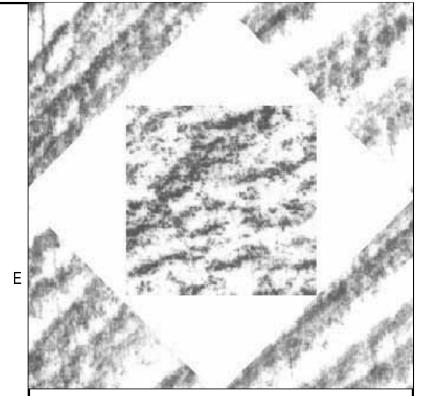


HFSArchitects


ARCHITECTUR INTERIOR


1484 South State Street Salt Lake City, Utah 84115 801-596-0691/F: 596-0693


CONSULTANT


GENERAL ABBREVIATIONS	GRAPHIC SYMBOLS	CODE REVIEW	DRAWING INDEX	PROJECT DIRECTORY	
	DTL# BLDG. ELEV. SYMB. RM. NAME RM. # RM. NAME/NUMB	APPLICABLE CODES		ARCHITECT	CAMP WILLIAMS BLDG
T. ACCOUSTIC CEILING TILE EXIST. EXISTING MATL. MATERIAL RET. RETAINING T. ALTERNATE EQ. EQUAL MAS. MASONRY REV. REVISED TIME OF THE OWNER OWNER OF THE OWNER	SHT# RM. NAME/NUMB RM. # RM. FINISH SYMB.	Year Year International Building Code 2006 National Electrical Code 2005	GENERAL DRAWINGS	HFS Architects 1484 SOUTH STATE STREET	1830 REMODEL
ANCHOR BOLT EXIST. EXISTING MFR. MANUFACTURER R.D. ROOF DRAIN AND EXP. EXPANSION M.H. MANHOLE RM. ROOM		International Mechanical Code 2006 Uniform Code for 1006 International Plumbing Code 2006 Building Conservation 2006	G101 TITLE SHEET, GENERAL INFORMATION & SHEET INDEX G102 CODE FLOOR AND SITE PLAN	Salt Lake City, Utah 84115	UTAH NATIONAL GUAF
CH. ARCHITECTURAL EXT. EXTERIOR M.O. MASONRY OPENING R.O. ROUGH OPENING AT OR AT THE MAX. MAXIMUM	DTL# BLDG. SECT. SYMB. XXXX CEIL. FINISH/ELEV. SYMB.	International Fire Code 2006 ADA Accessibility International Energy Guidelines 2003	ARCHITECTURAL DRAWINGS	801-596-0691/Fax 801-596-0693	
BEAM F.A. FIRE ALARM MEMB. MEMBRANE SEAL. SEALANT BLOCK F.E. FIRE EXTINGUISER MEN MEN'S TOILET SECT. SECTION	SHI#)	Conservation Code 2006	AS101 SITE PLAN AND ROOF PLAN	MECHANICAL ENGINEER	
G. BLOCKING F.E.C. F.E. CABINET MTL./MET. METAL S.SK. SERVICE SINK BOARD FLR./FL. FLOOR MIN. MINIMUM SHT. SHEET	DTL# SHT# DETAIL REF. SYMB.	A. Occupancy and Group: B A-3 S1	AD101 DEMOLITION PLAN BASE BID	David L. Jensen & Associates 547 West 500 SOuth Suite 140	
T. BOTTOM F.D. FLOOR DRAIN MIR. MIRROR SIM. SIMILAR DG. BUILDING F.O.S. FACE OF STUD MISC. MISCELLANEOUS SL./SLP. SLOPE F.O.W. FACE OF WALL MTD. MOUNTED S.C. SOLID CORE	DTL# WALL SECT. SYMB.	Change in Use: Yes No <u>X</u> Mixed Occupancy: Yes No <u>X</u> Special Use and Occupancy (e.g. High Rise, Covered Mall): <u>NO</u>	AD102 DEMOLITION PLAN ALTERNATES AE101 FLOOR PLAN BASE BID	Bountiful, Utah 84010	C
CARPET FTG. FOOTING MUL. MULLION SPEC. SPECIFICATIONS G. CAULKING FDN. FOUNDATION SQ. SQUARE	DTL# SHT# INTR. ELEV. SYMB.	B. Seismic Design Category: Design Wind Speed: mph	AE102 FLOOR PLAN ALTERNATES AE110 REFLECTED CEILING PLAN BASE BID	801-294-9299/Fax 801-294-9399	
S. CEILING N. NORTH STL. STEEL M. CEMENT GALV GALVANIZED N.I.C. NOT IN CONTRACT STOR. STORAGE	SHI #	C. Type of Construction (circle one): τ τ π π π π π π ν ν ν	AE111 REFLECTED CEILING PLAN ALTERNATES	ELECTRICAL ENGINEER	
. CENTER G.I. GALYANIZED IRON N.T.S. NOT TO SCALE STRUCT STRUCTURAL/STRUCTURE CENTER LINE GA. GAUGE NO. NUMBER SYM. SYMMETRICAL	T.O. DATUM PT. SYMB.	$\frac{1}{A}$ $\frac{1}{B}$ $\frac{1}{A}$ $\frac{1}{B}$ $\frac{1}{A}$ $\frac{1}{B}$ $\frac{1}{B}$ $\frac{1}{B}$	AE401 INTERIOR ELEVATIONS, DETAILS	Electrical Engineering & Lighting Design	
C. CERAMIC GL. GLASS CERAMIC TILE GR. GRADE OR # ORDINATE NUMBER T.B.R. TO BE REMOVED CLEAR (ANCE) GND. GROUND OFF. OFFICE TEL. TELEPHONE	DR. # DOOR/HDWR. SYMB.	D. Fire Resistance Rating Requirements for the Exterior Walls based on the fire separation distance (in hours):	MECHANICAL / PLUMBING DRAWINGS	1220 South 300 West Salt Lake City, Utah 84101	
O. CLOSET GYP. BD. GYPSUM BOARD O.C. ON CENTER TEMP. TEMPORARY / TEMPERED COLUMN GWB GYPSUM WATERPROOF BOARD OPNG. OPENING THK. THICK (NESS)	ELEV SPOT ELEV, SYMB. # WINDOW TYPE	North: <u>- 0 -</u> South: <u>- 0 -</u> East: <u>- 0 -</u> West: <u>- 0 -</u>	PL101 PLUMBING REMODEL PLANS BASE BID	801-486-2222/Fax 801-474-3353	
NC. CONCRETE OPP. OPPOSITE T & G TONGUE AND GROOVE J CONCRETE MASONRY UNIT H.D.P.E. HIGH DENSITY POLYETHYLENE OPP. H. OPPOSITE HAND T/CONC TOP OF CONCRETE CORRUGATED METAL PIPE HG# HARDWARE GROUP # 0.D. OUTSIDE DIAMETER T/CURB TOP OF CURB	WINDOW III E	E. Mixed Occupancies: <u>NONE</u> Nonseparated Uses: <u>NO</u> F: Sprinklers:	PL102 PLUMBING REMODEL PLANS ALTERNATE		
IN. CONNECTION HDWD. HARDWOOD O.R.D. OVERFLOW ROOF DRAIN T.O. FTG. TOP OF FOOTING ISTR. CONSTRUCTION HT. HEIGHT T.O.P. TOP OF PLATE	MATERIALS LEGEND	Required: <u>NO</u> Provided: <u>YES</u> Type of Sprinkler System: <u>WET</u>	P401 PLUMBING LARGE SCALE PLAN P501 PLUMBING DETAILS, LEGEND & SCHEDULES		
IT. CONTINUE/CONTINUOUS H.P. HIGH POINT PTDE PAINTED EPOXY T/WALL TOP OF WALL ITR. CONTRACTOR HORIZ. HORIZONTAL PTD. PAINTED T. TREAD CONTROL JOINT H.B. HOSE BIBB PR. PAIR TYP. TYPICAL		G: Number of Stories: <u>1</u> Building Height: <u>19'-0"</u> H: Actual Area per Floor (square feet): 13, 331 SF	MD101 MECHANICAL DEMOLITION PLANS MH101 MECHANICAL REMODEL PLANS BASE BID		
R. CORRIDOR H.M. HOLLOW METAL PART. PARTITION R. COUNTER HR. HOURS (FIRE RATING) PED. PEDESTRIAN UNF. UNFINISHED K. COUNTERSUNK PLAS. PLASTER U.N.O. UNLESS NOTED OTHERWISE		I: Tabular Area: 23,000 sf	MH102 MECHANICAL REMODEL PLANS ALTERNATE		
IN. INCH P. LAM. PLASTIC LAMINATE DETAIL I.D. INGIDE DIAMETER PL PLATE VAR. VARY OR VARIES	EARTH GRAVEL	J: Area Modifications:	M501 MECHANICAL DETAILS & LEGEND M601 MECHANICAL SCHEDULES		
DEPARTMENT INSUL. INSULATION PLYWD. PLYWOOD VERT. VERTICAL DIAMETER INT. INTERIOR PT. POINT V.T.R. VENT THROUGH ROOF		a) $A_a = A_t + \left[\frac{A_t I_f}{100}\right] + \left[\frac{A_t I_s}{100}\right]$ $I_f = 100 \left[\frac{F}{P} - 0.25\right] \frac{W}{30}$			
DOWN Q.T. QUARRY TILE DOWNSPOUT JAN. JANITOR W/ WITH	SAND CONCRETE	b) Sum of the Ratio Calculations for Mixed Occupancies:	ELECTRICAL DRAWINGS		
DRAWING JT. JOINT RAD. RADIUS W.A.S. WELDED ANCHOR STUD DRINKING FOUNTAIN J-BOX JUNCTION BOX R.B. RUBBER BASE WD. WOOD R.W.L. RAIN WATER LEADER WP. WATERPROOF		Actual Area ≤ 1	EE-001 GENERAL NOTES, SCHEDULES, DETAILS, & DIAGRAMS		
EAST KIT. KITCHEN R.F.F. REFERENCE FINISH FLOOR WSCT. WAINSCOT FACH REFL. REFLECTED W/O WITHOUT	CMU CAST STONE	Allowable Area c) Total Allowable Area for:	ED-101 BASE BID & ALTERNATE PLANS - ELECTRICAL DEMOLITION EP-101 ALTERNATE FLOOR PLANS AND BASE BID - POWER		
C. ELECTRIC (AL) LAM. LAMINATE REINF. REINFORCING W.P. WORKING POINT //EL. ELEVATION LAV. LAVATORY REQ. REQUIRED W.R. WATER RESISTANT LT. LIGHT WII. WROUGHT IRON	CAST STONE	1) One Story:	EL-101 ALTERNATE FLOOR PLANS AND BASE BID - LIGHTING		В
L.P. LOW POINT	BRICK NATURAL STONE	2) Two Story: A _a (2) 3) Three Story: A _a (3)			
		d) Unlimited Area Building: Yes No _X_ Code Section:			MARK DATE DESCRIPTION 7-21-2008 DFCM REVIEW COM
	WOOD (BLOCKING) PLYWOOD	K. Fire Resistance Rating Requirements for Building Elements (hours). Element Hours Assembly Element Hours Assembly			8-8-2008 DFCM REVIEW COI
		Exterior Bearing Walls N/A Floors - Ceiling Floors N/A			
	WOOD WOOD FRAMING FINISH	Interior Bearing Walls Exterior Non-Bearing Walls Structural Frame N/A Roofs - Ceiling Roofs Exterior Doors and Windows N/A Shaft Enclosures N/A N/A			
		Structural FrameN/AShaft EnclosuresN/APartitions - PermanentN/AFire WallsN/AFire BarriersN/AFire Partitions1			
	STEEL BATT INCLUDED	N/A Smoke Partitions N/A			DATE: Jui
	INSULATION	L. Design Occupant Load: 315 Exit Width Required: 4'-0" Exit Width Provided: 4'-2"		DEFERRED SUBMITTALS	PROJECT NO: HFSA PROJECT NO:
	COMPRESSIBLE RIGID	M. Minimum Number of Required Plumbing Facilities:	<u> </u>	- SEISMIC BRACING DETAILS - MECHANICAL UNITS & DUCTS - MARCH 2009.	CAD DWG FILE NO:
	FILLER INSULATION	a) Water Closets - Required (m) <u>4</u> (f) <u>4</u> Provided (m) <u>5</u> (f) <u>4</u> b) Lavatories - Required (m) <u>3</u> (f) <u>3</u> Provided (m) <u>3</u> (f) <u>3</u>			DRAWN BY: CHECKED BY:
	V V EENCE BACKER ROD AND	c) Bath Tubs or Showers: <u>- 0 -</u> d) Drinking Fountains: <u>1</u> Service Sinks: <u>1</u>			DESIGNED BY: DWG TYPE: A
	X — X — FENCE BACKER ROD AND FILLER	FOOTNOTES:			ARCHITECTURAL PHASE:
		1) In case of conflict with the U.S. Department of Justice Federal Registers Parts I through ∑ - ADA Guidelines and specific reference to the International Building			Construction Do
		Code Accessibility Chapters, the more restrictive requirement shall govern. 2) Additional Code Information shall be provided at the discretion of the Building			TITLE SHEET,
		Official for Complex Buildings. Including, but not limited to: a) High Rise Requirements.			GENERAL INFO.
		b) Atriums. c) Performance Based Criteria.			& SHEET INDEX
		d) Means or Egress Analysis. e) Fire Assembly Locator Sheet.			
		f) Exterior and Interior Accessibility Route. g) Fire Stopping, Including Tested Design Number.			G101
		g, indicapping, indicang rested besign number.	I and the second		-

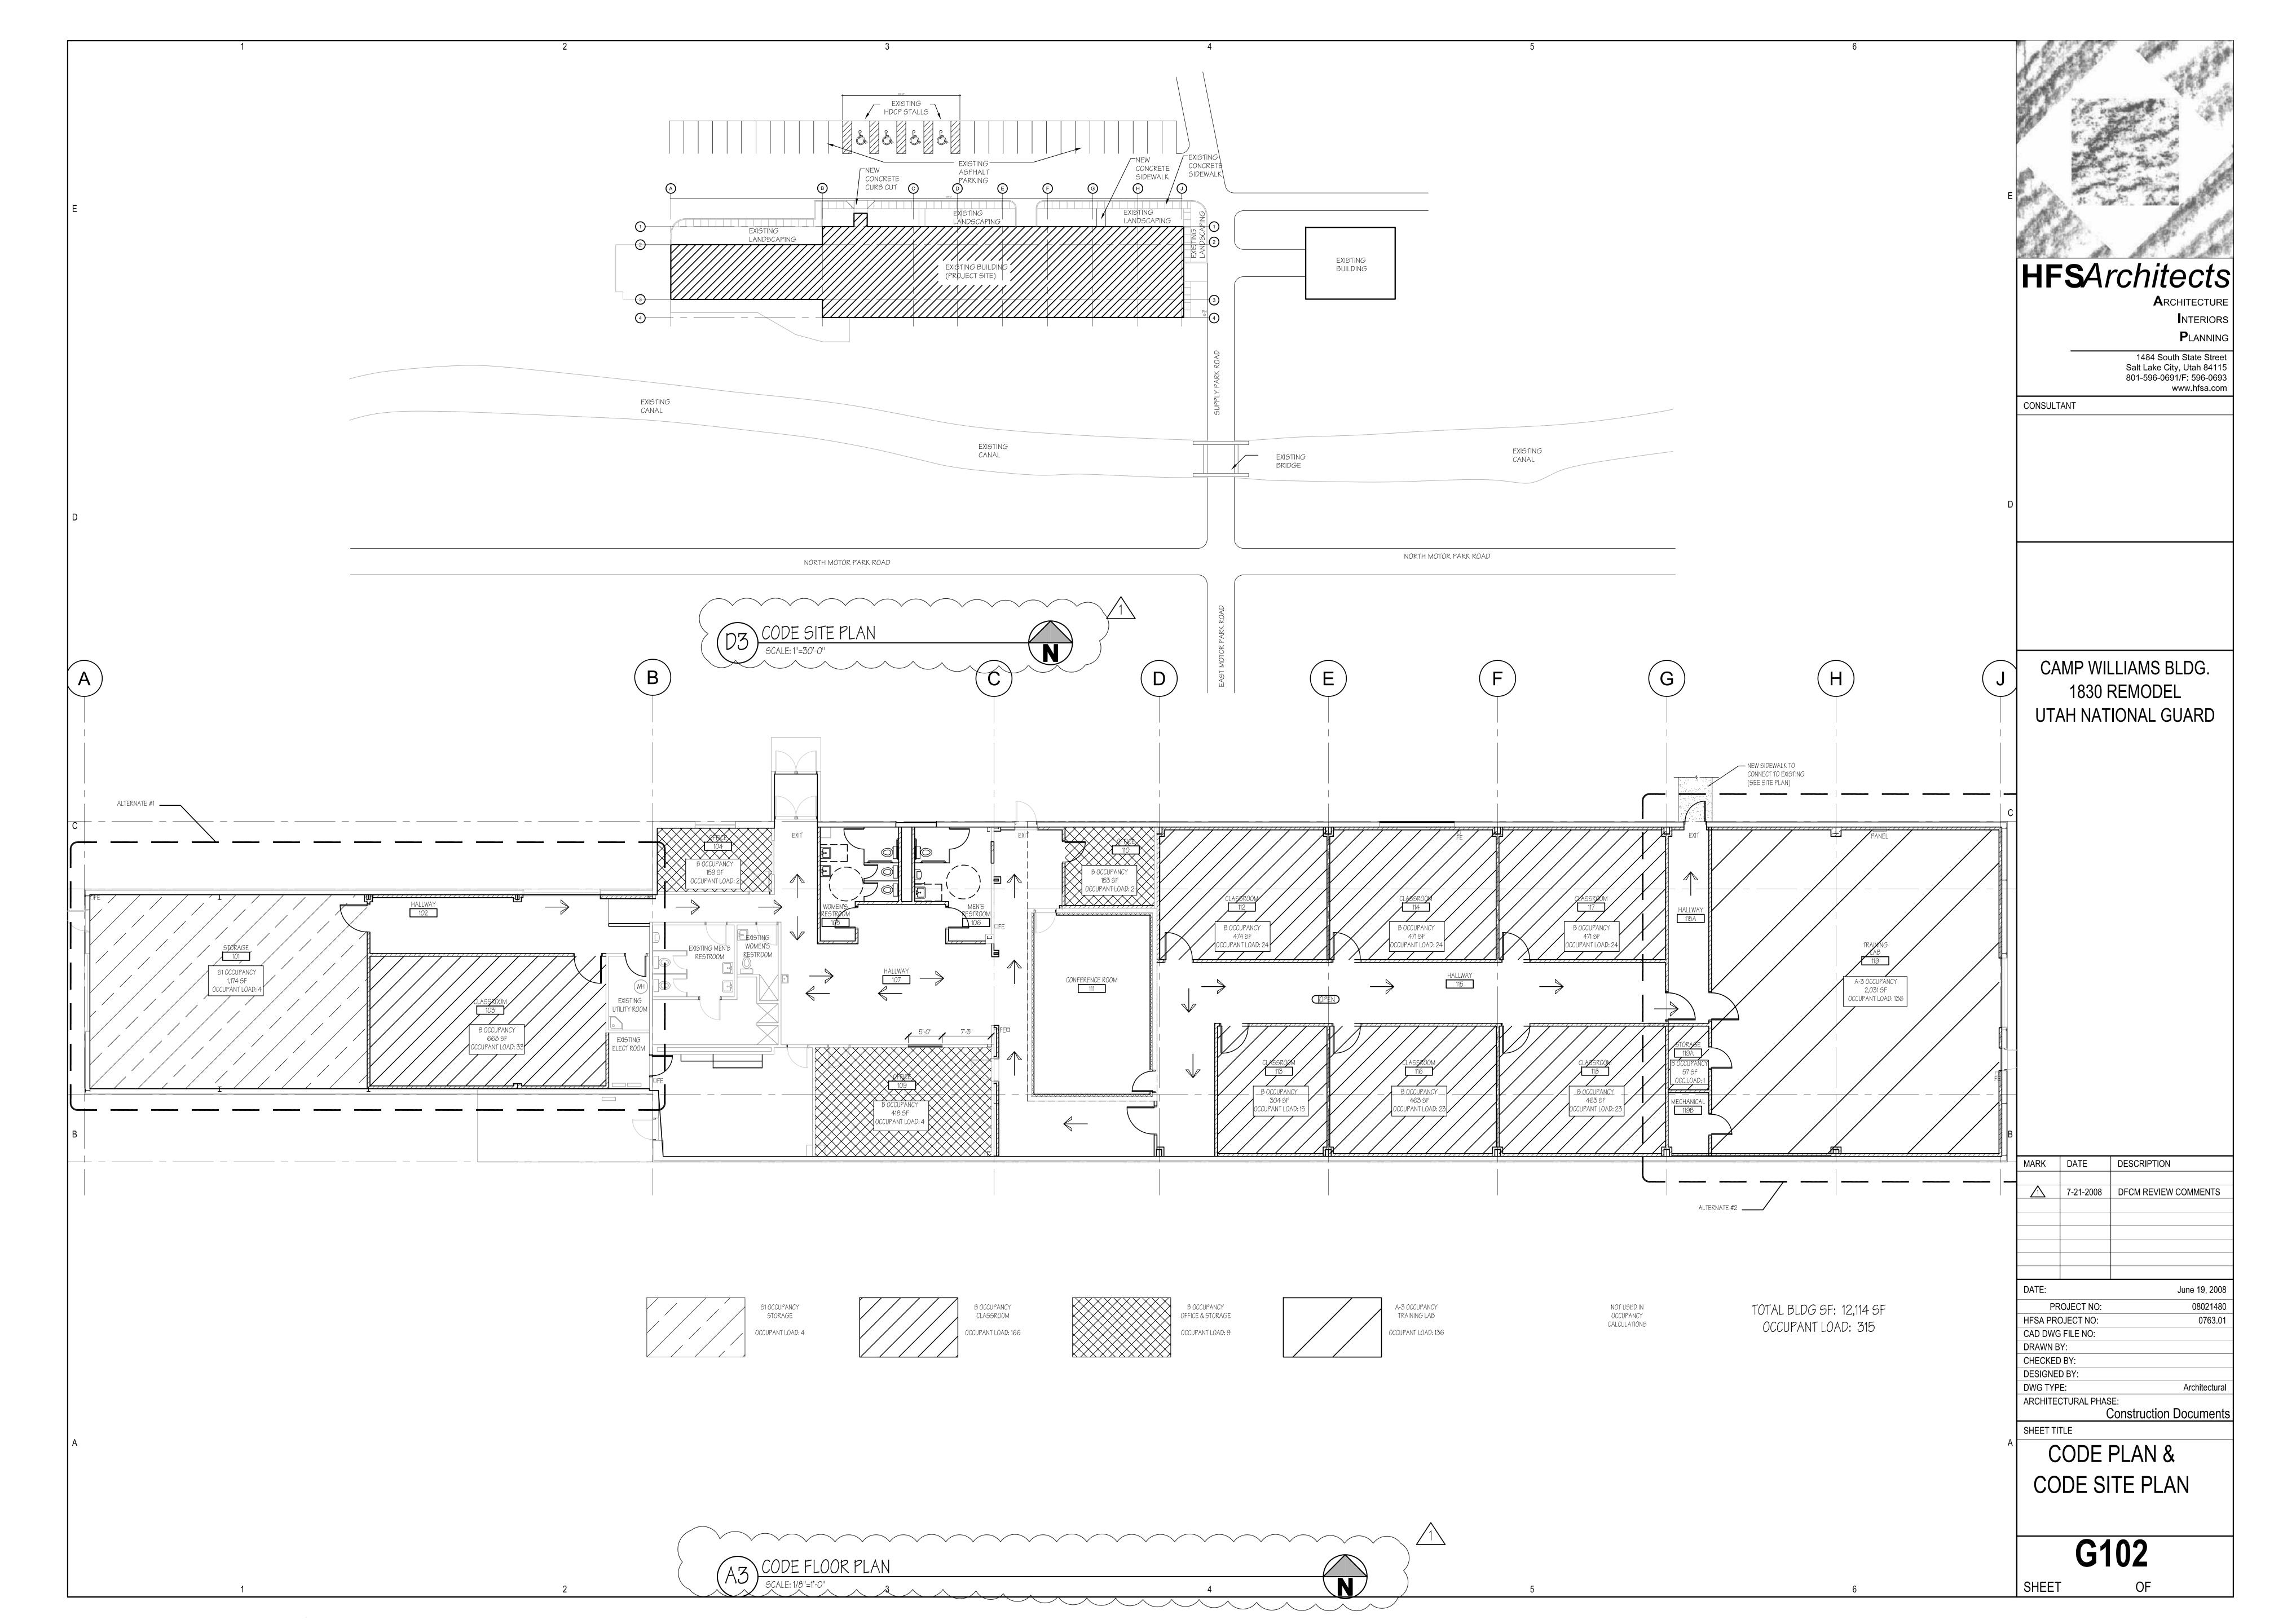


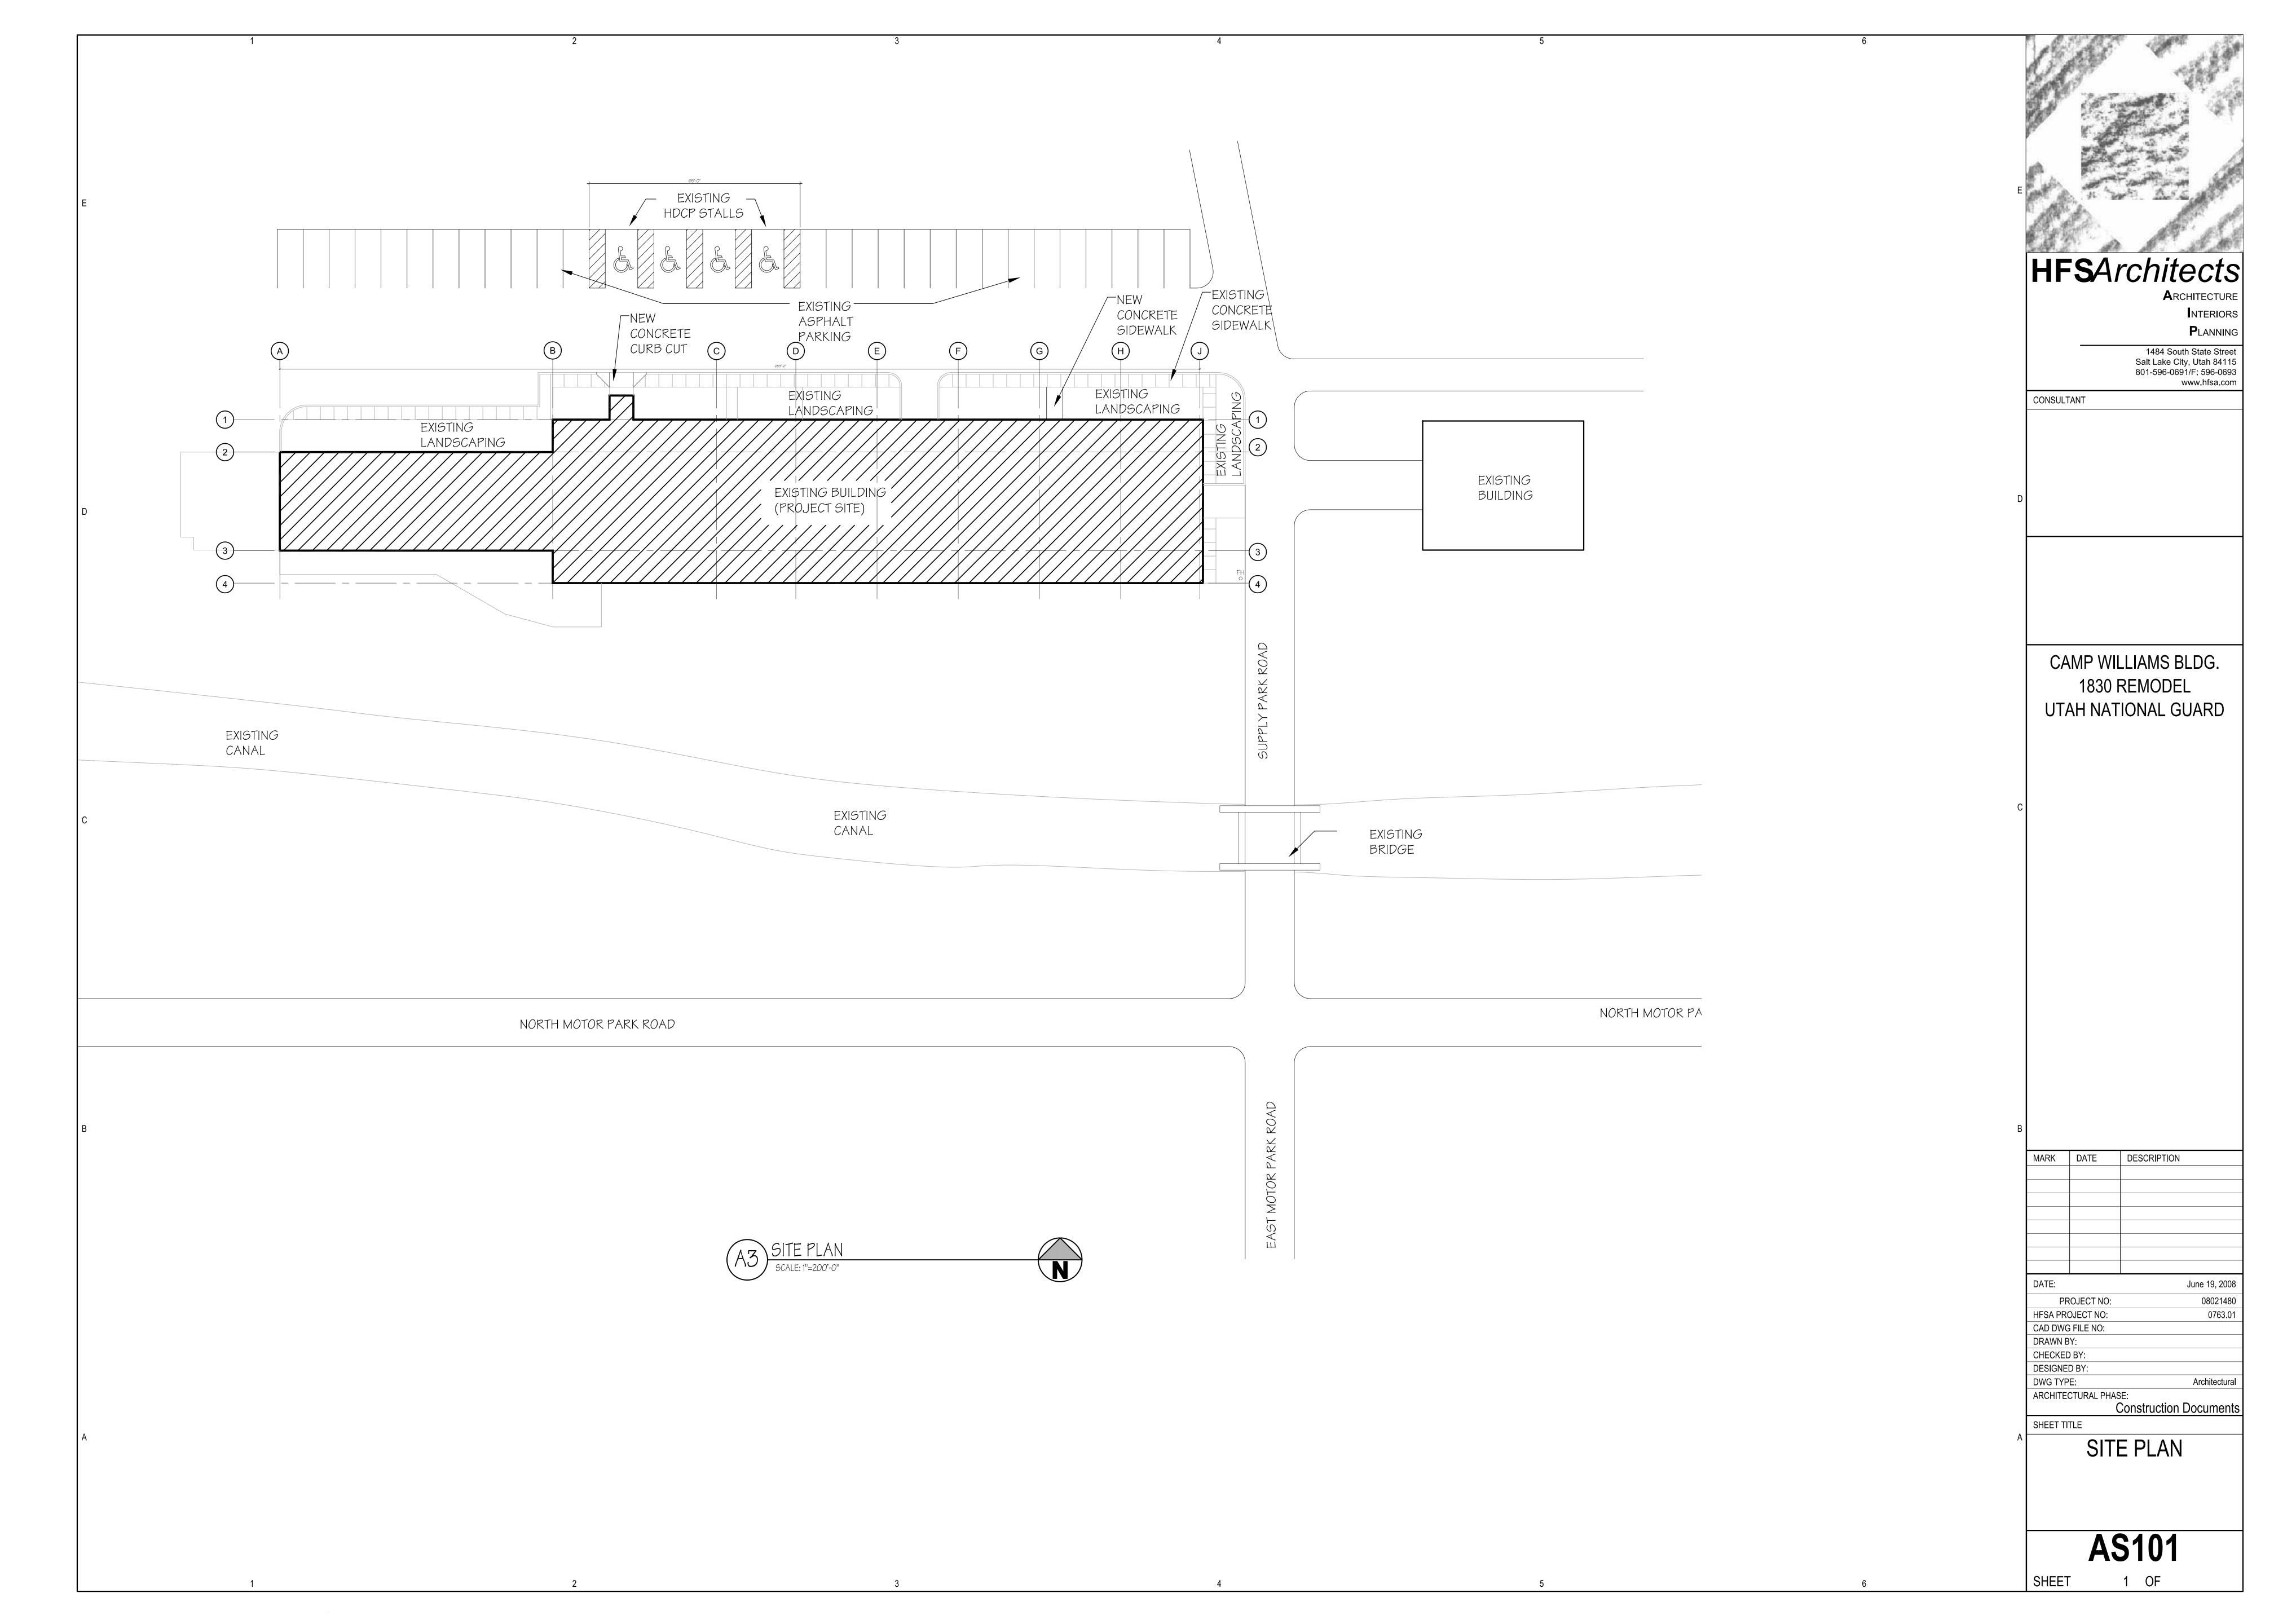

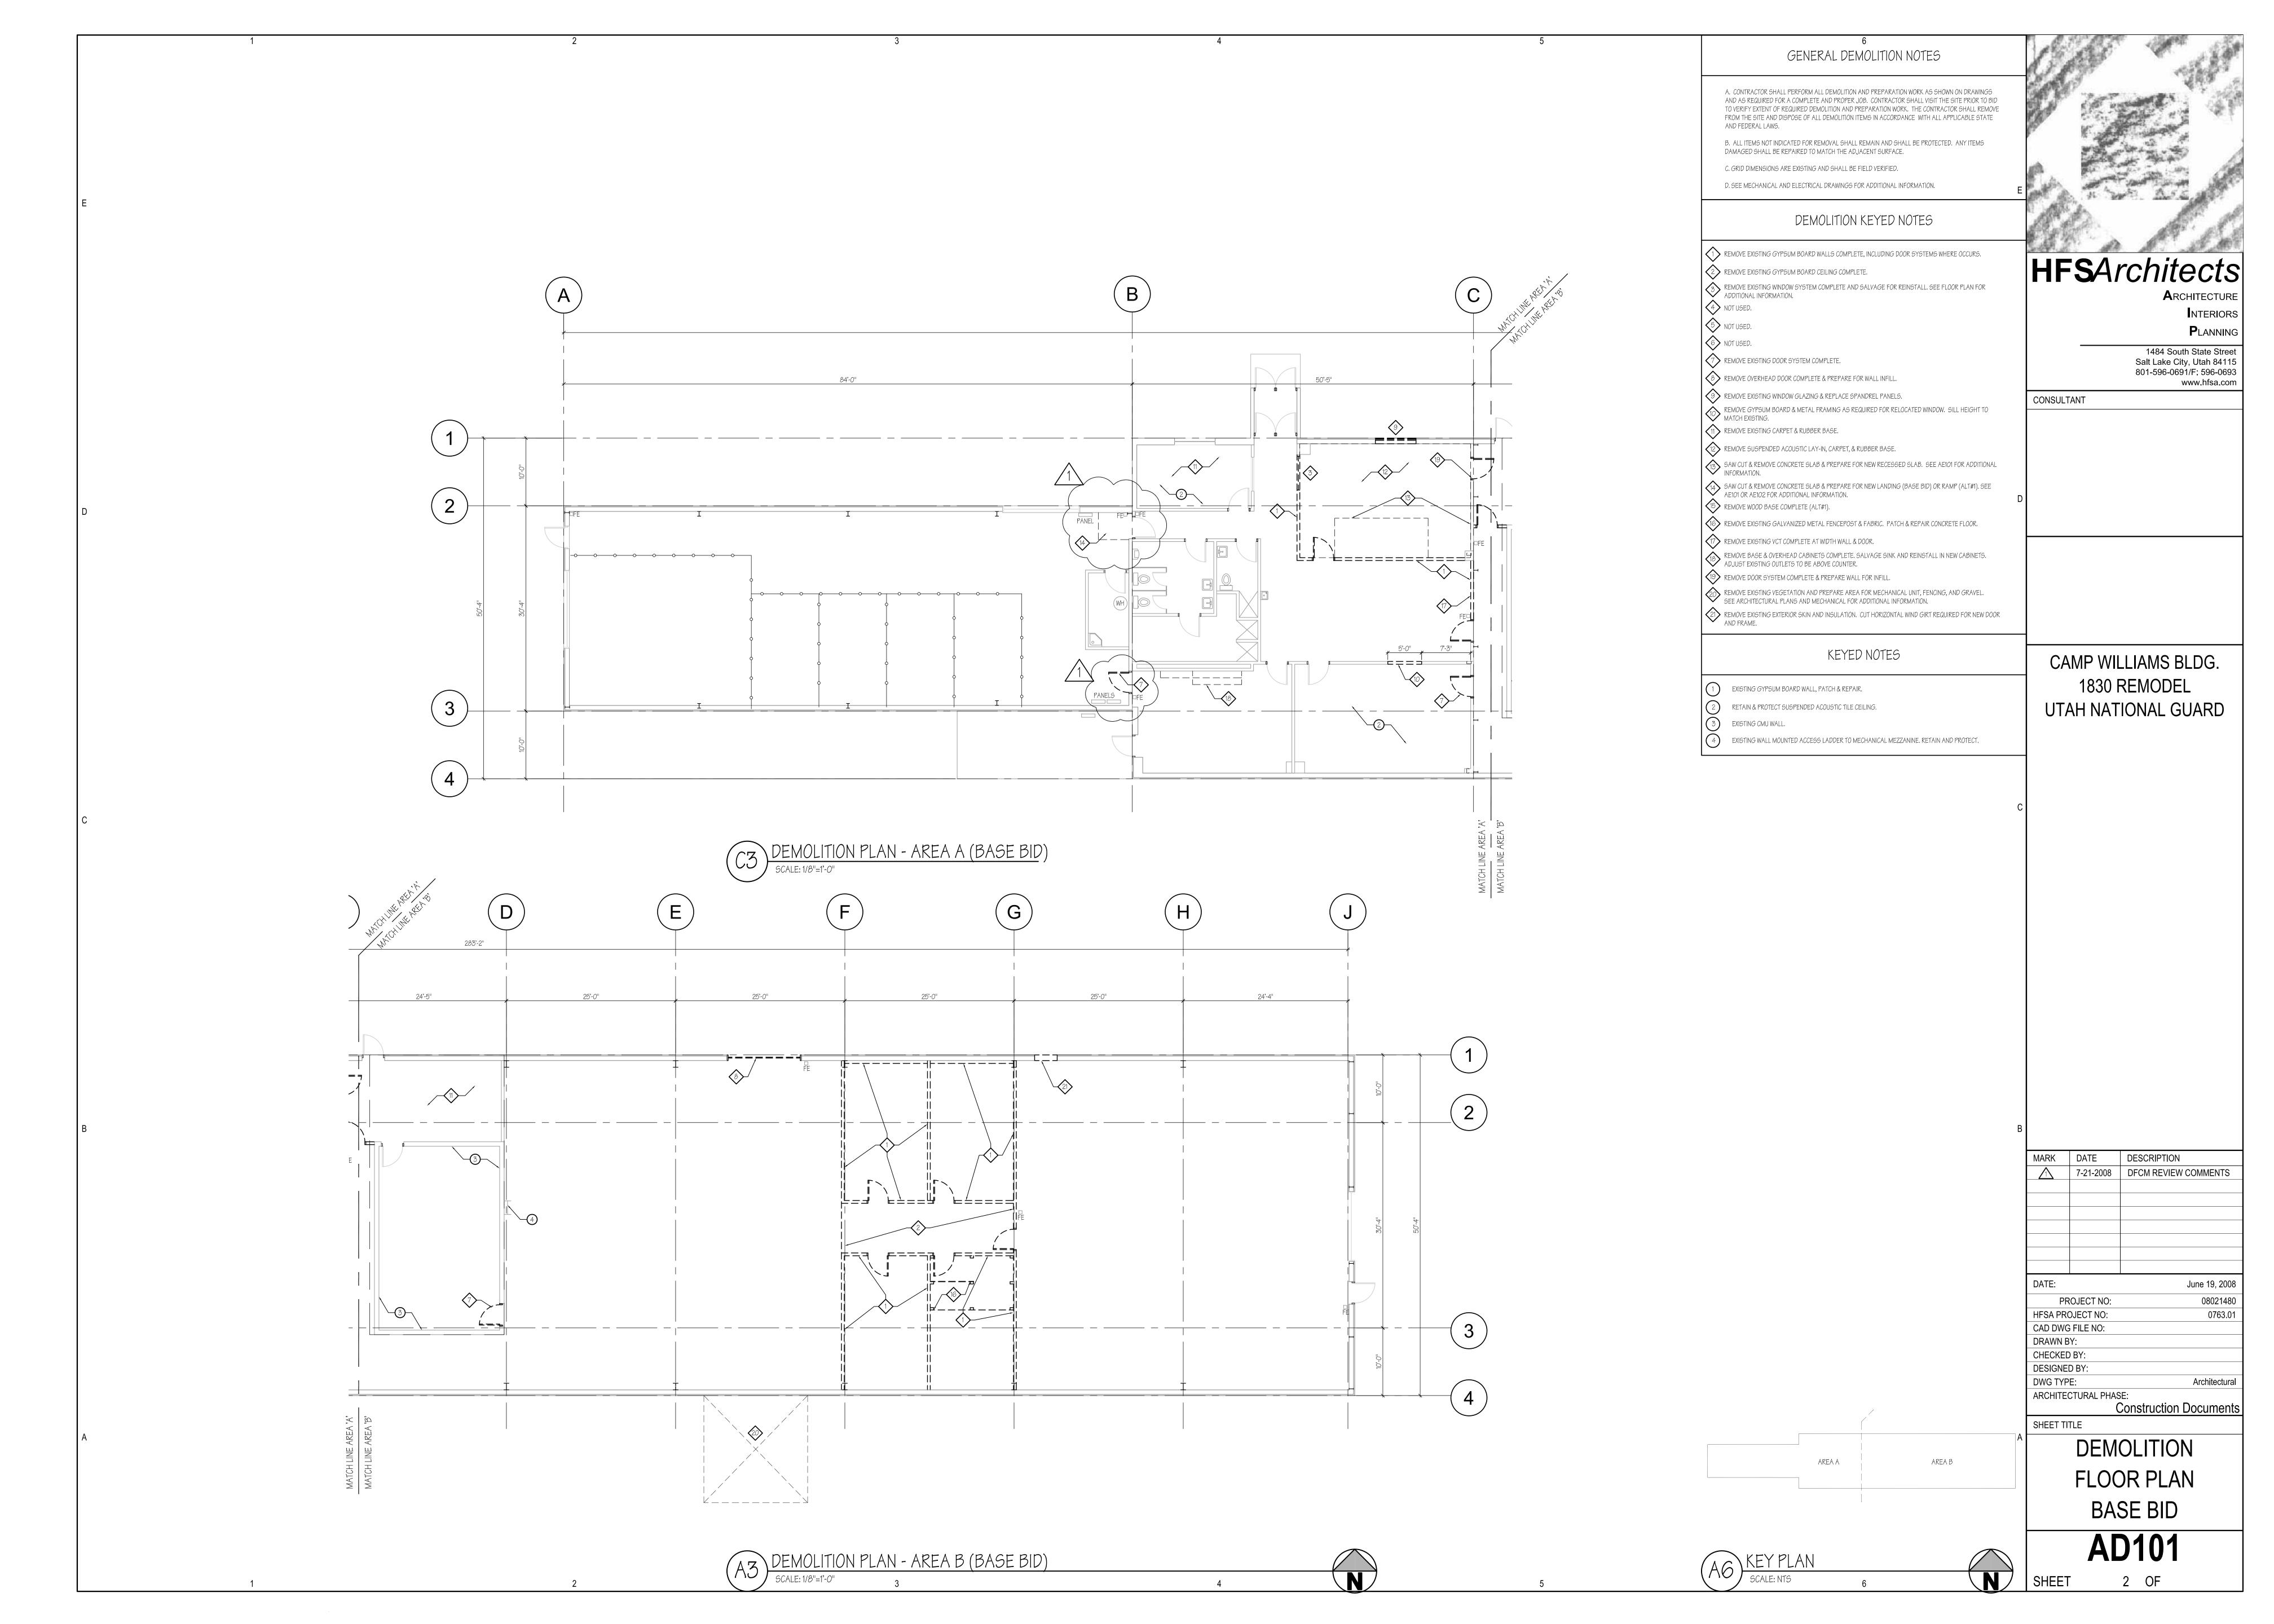

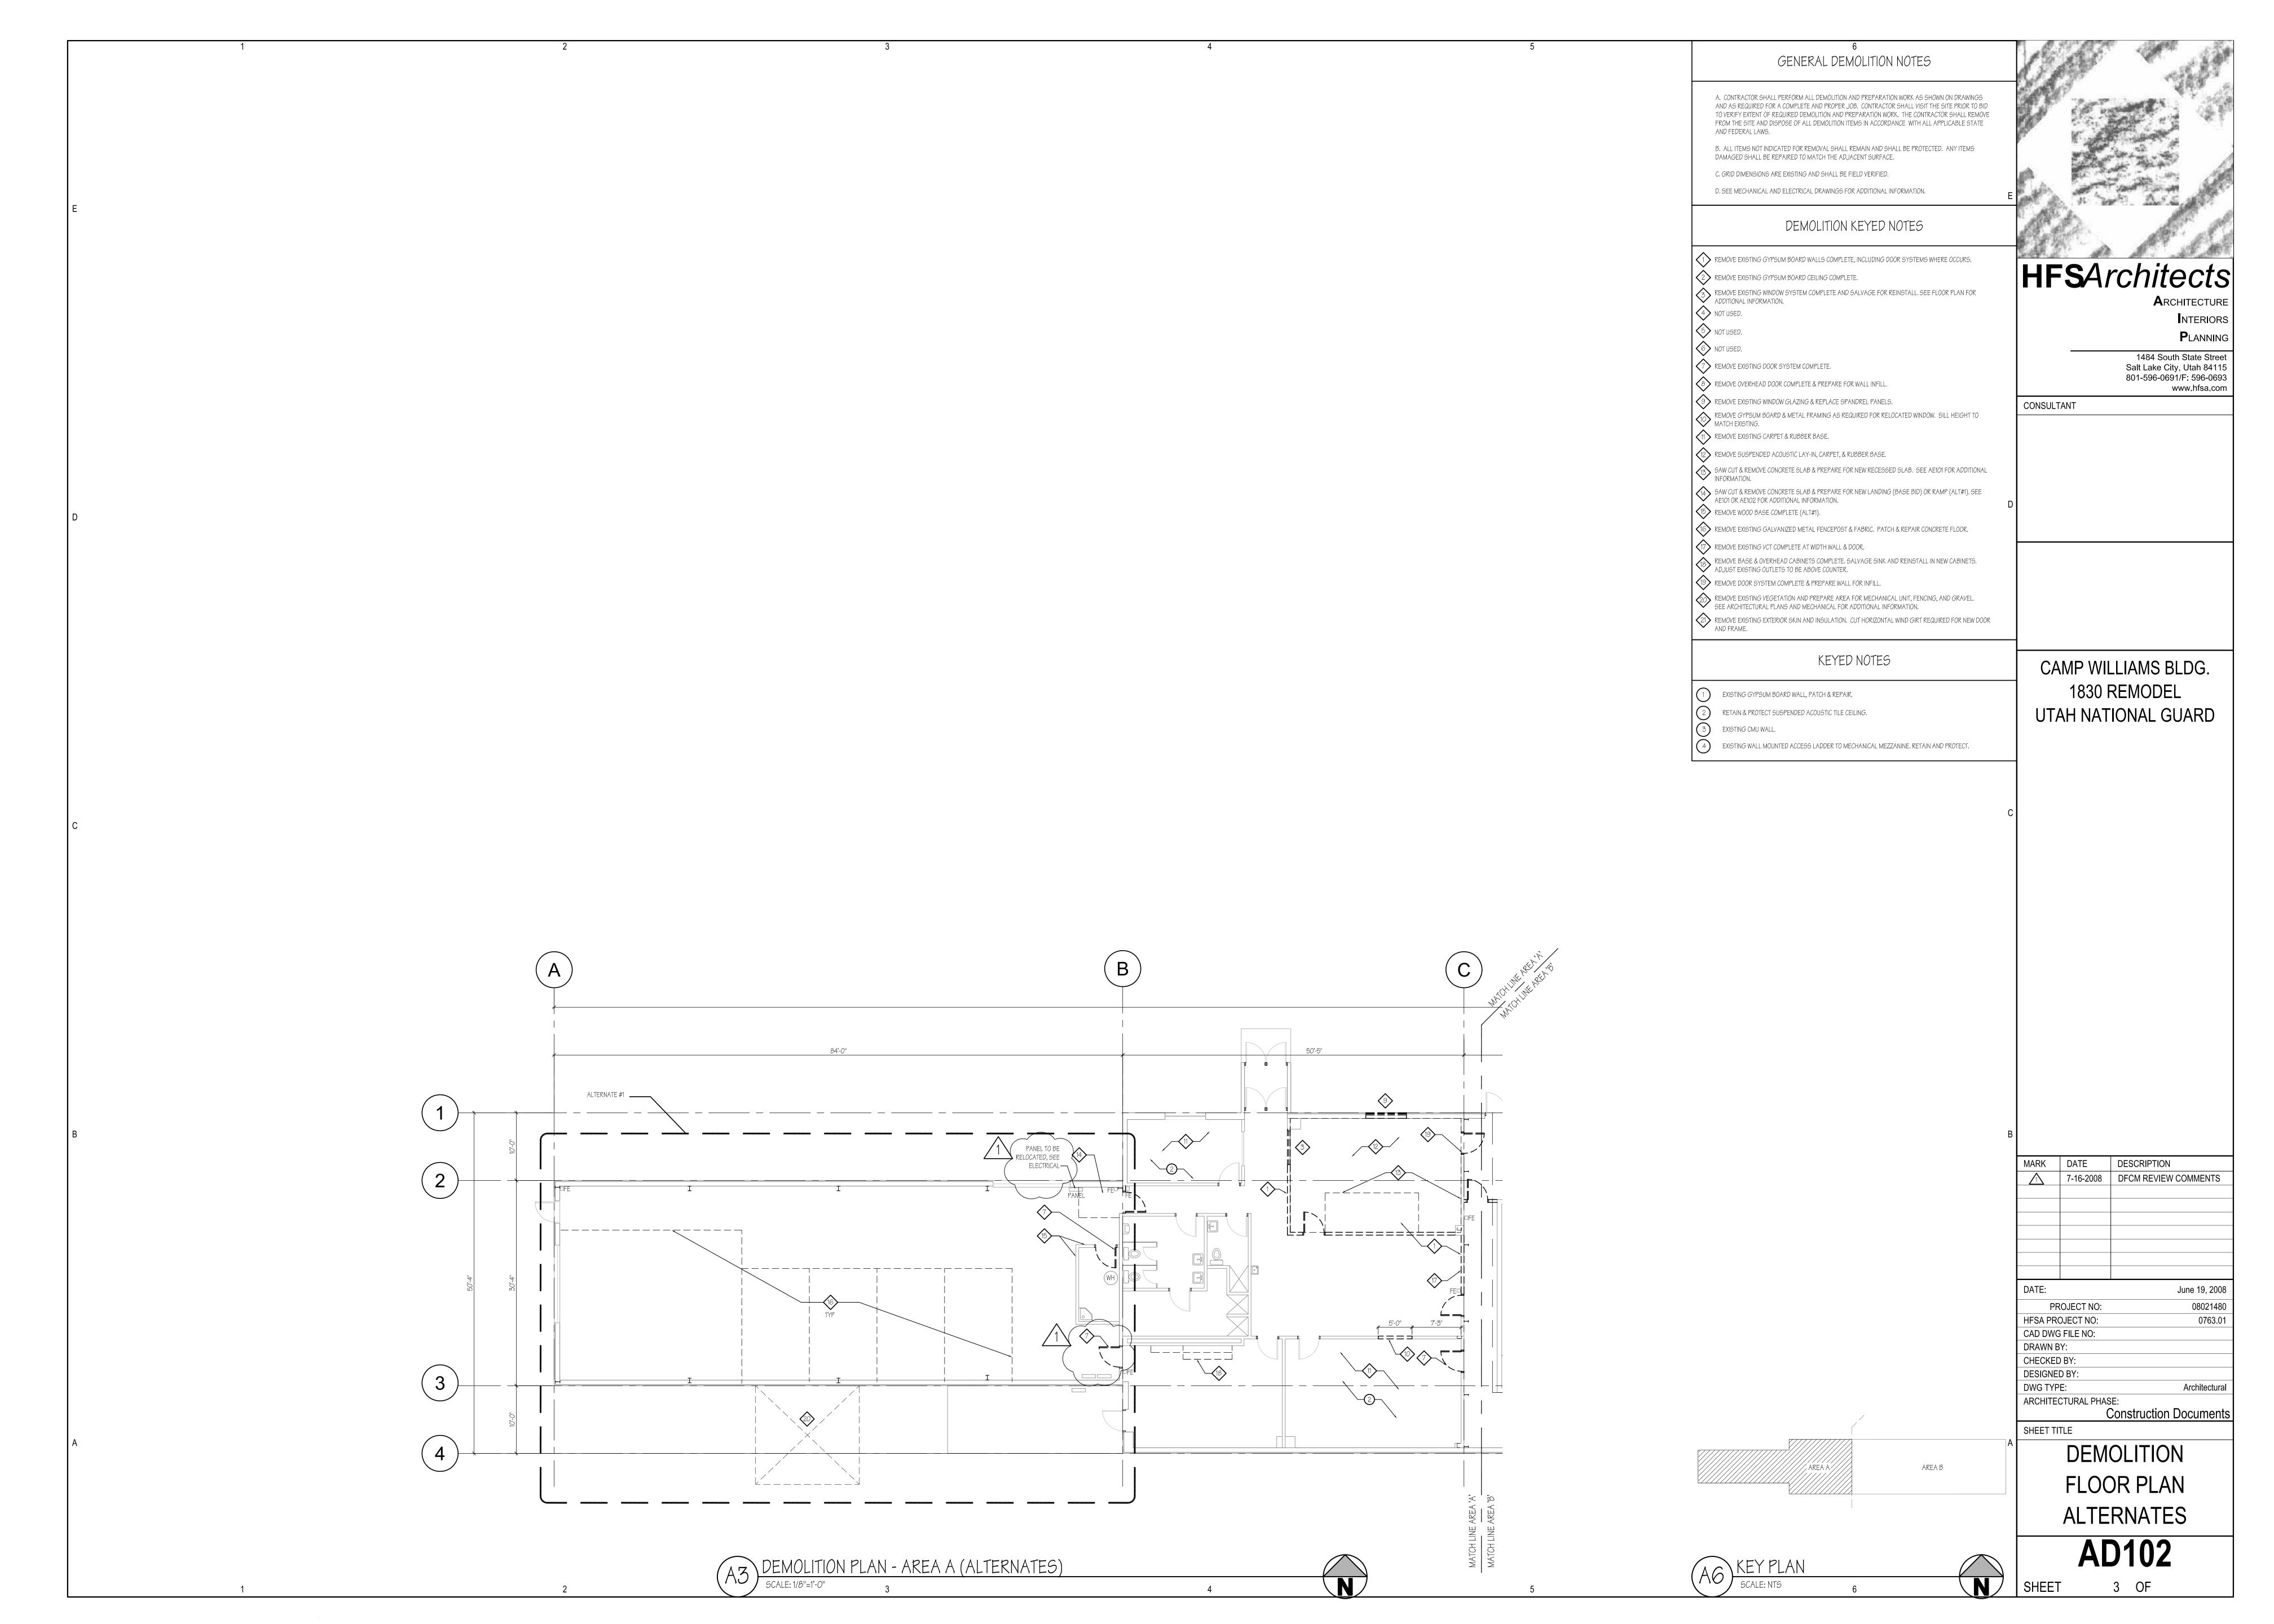

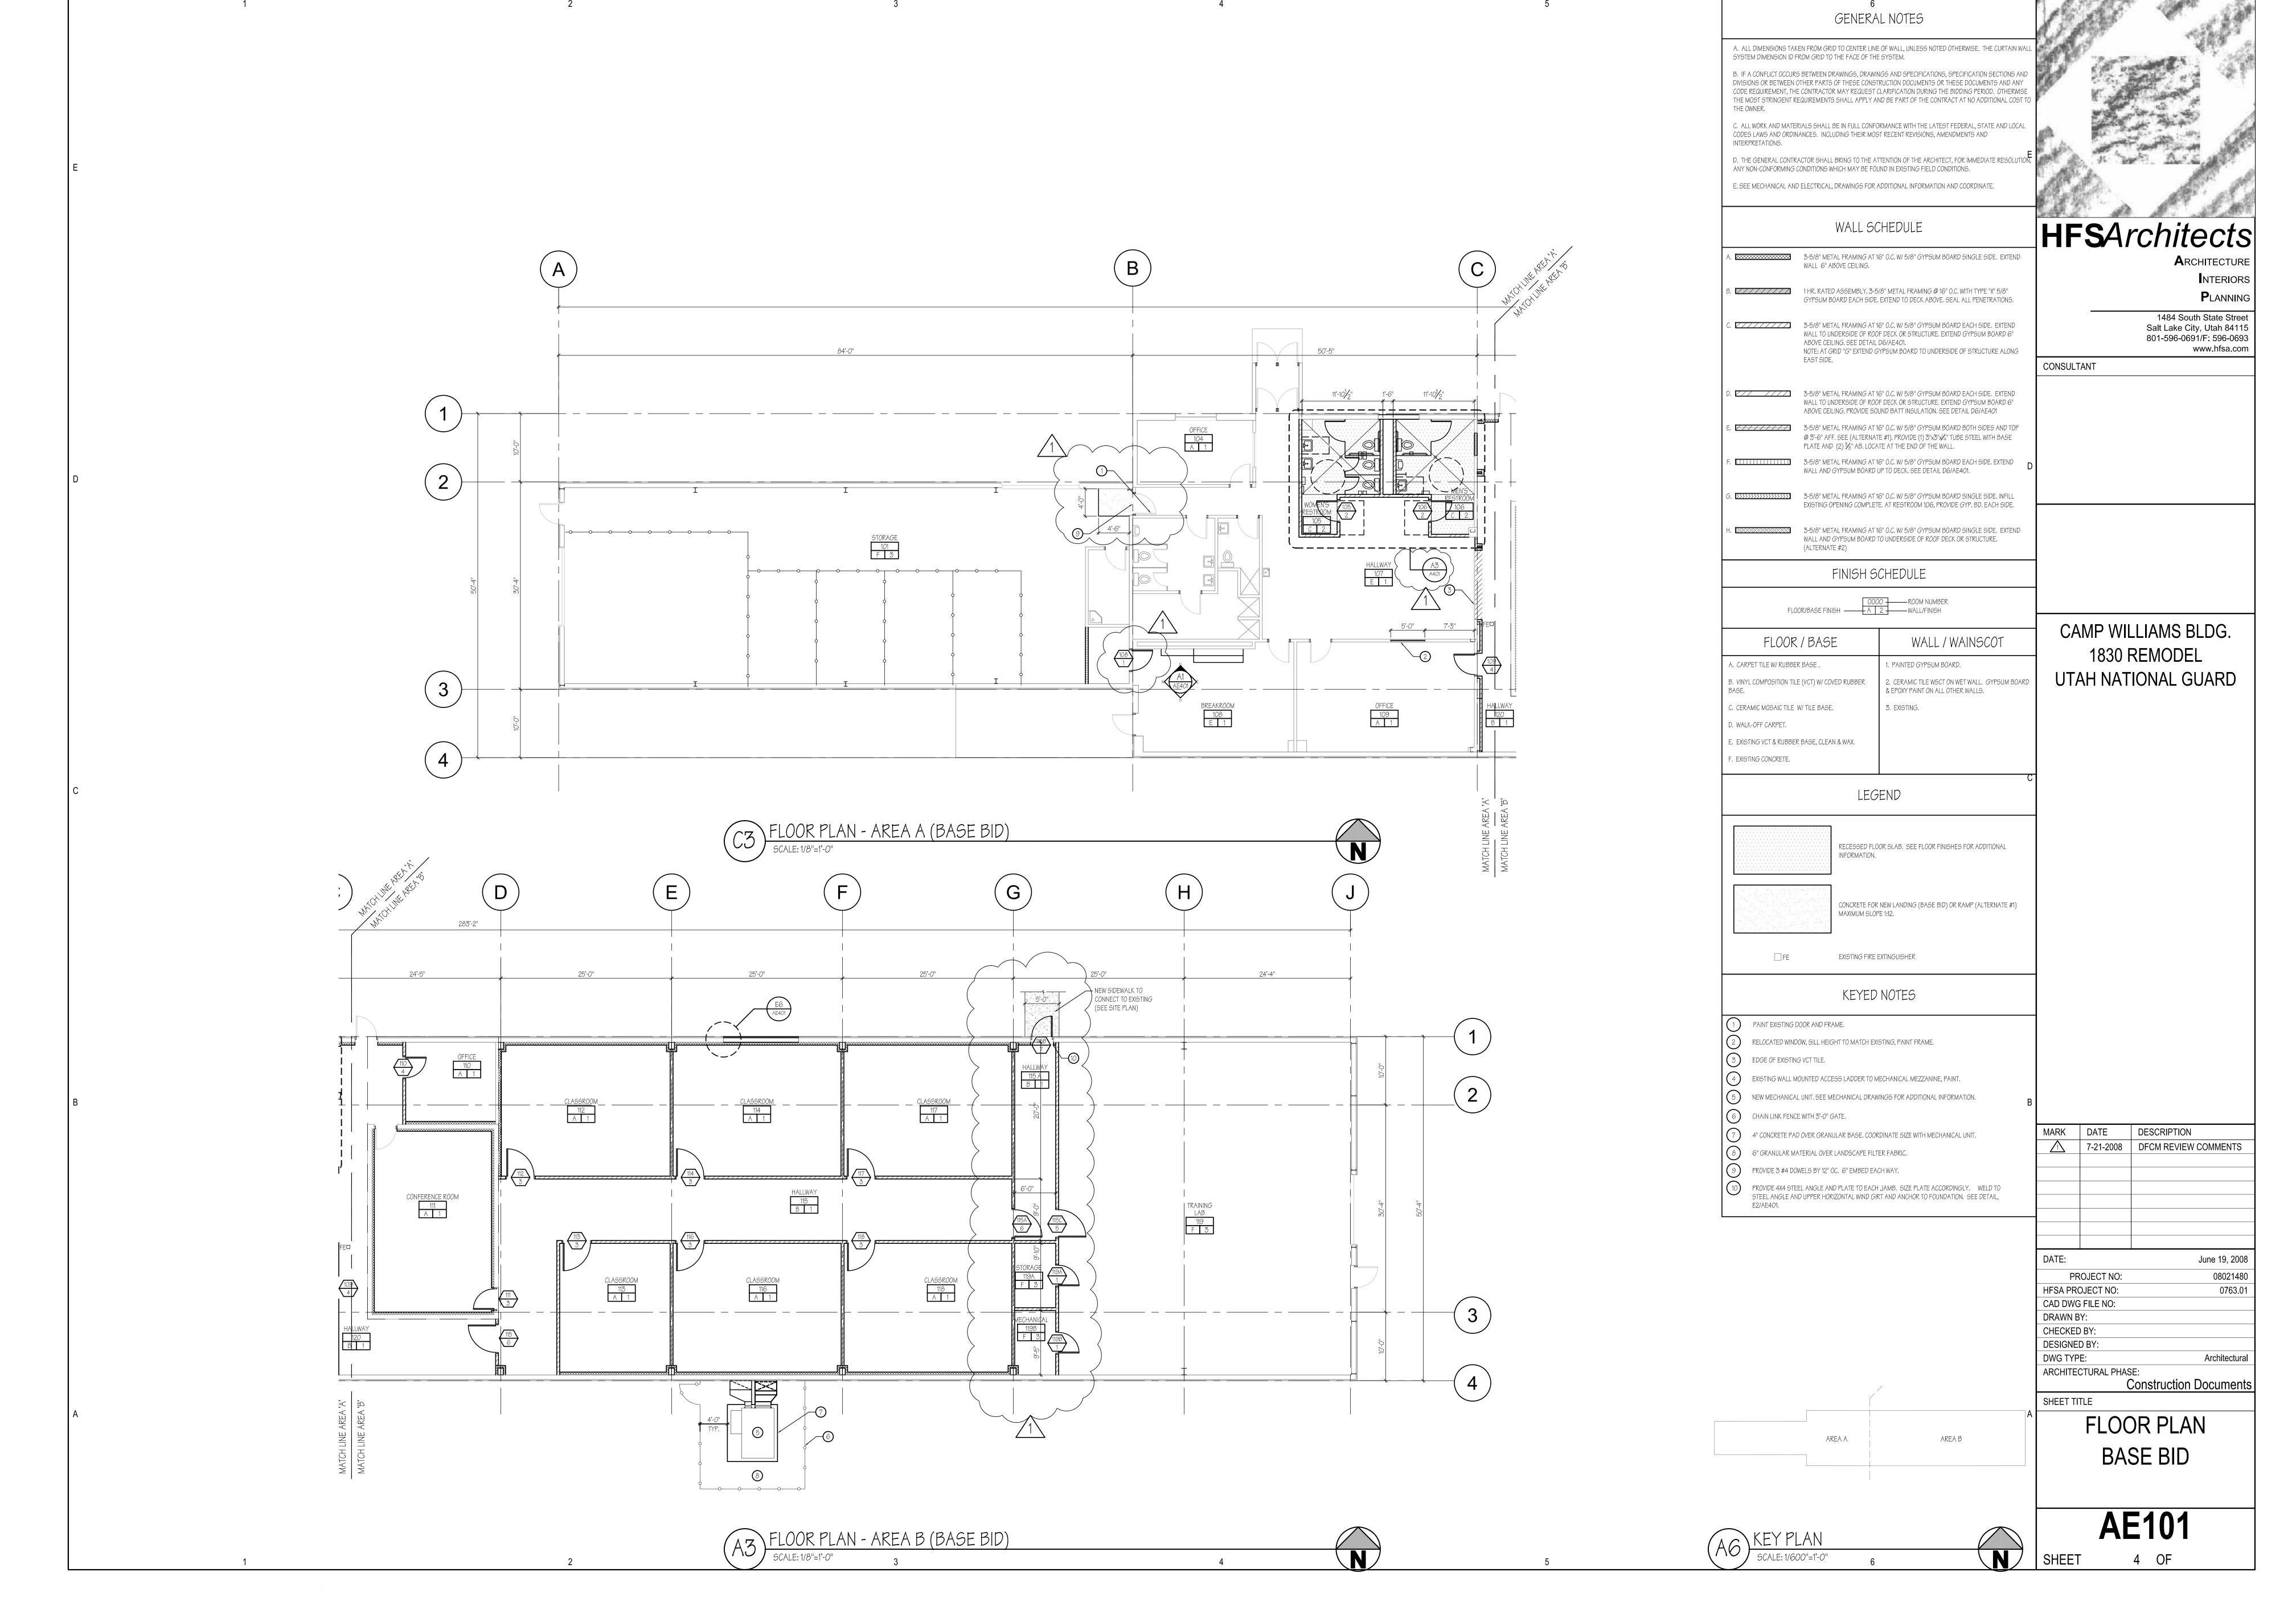

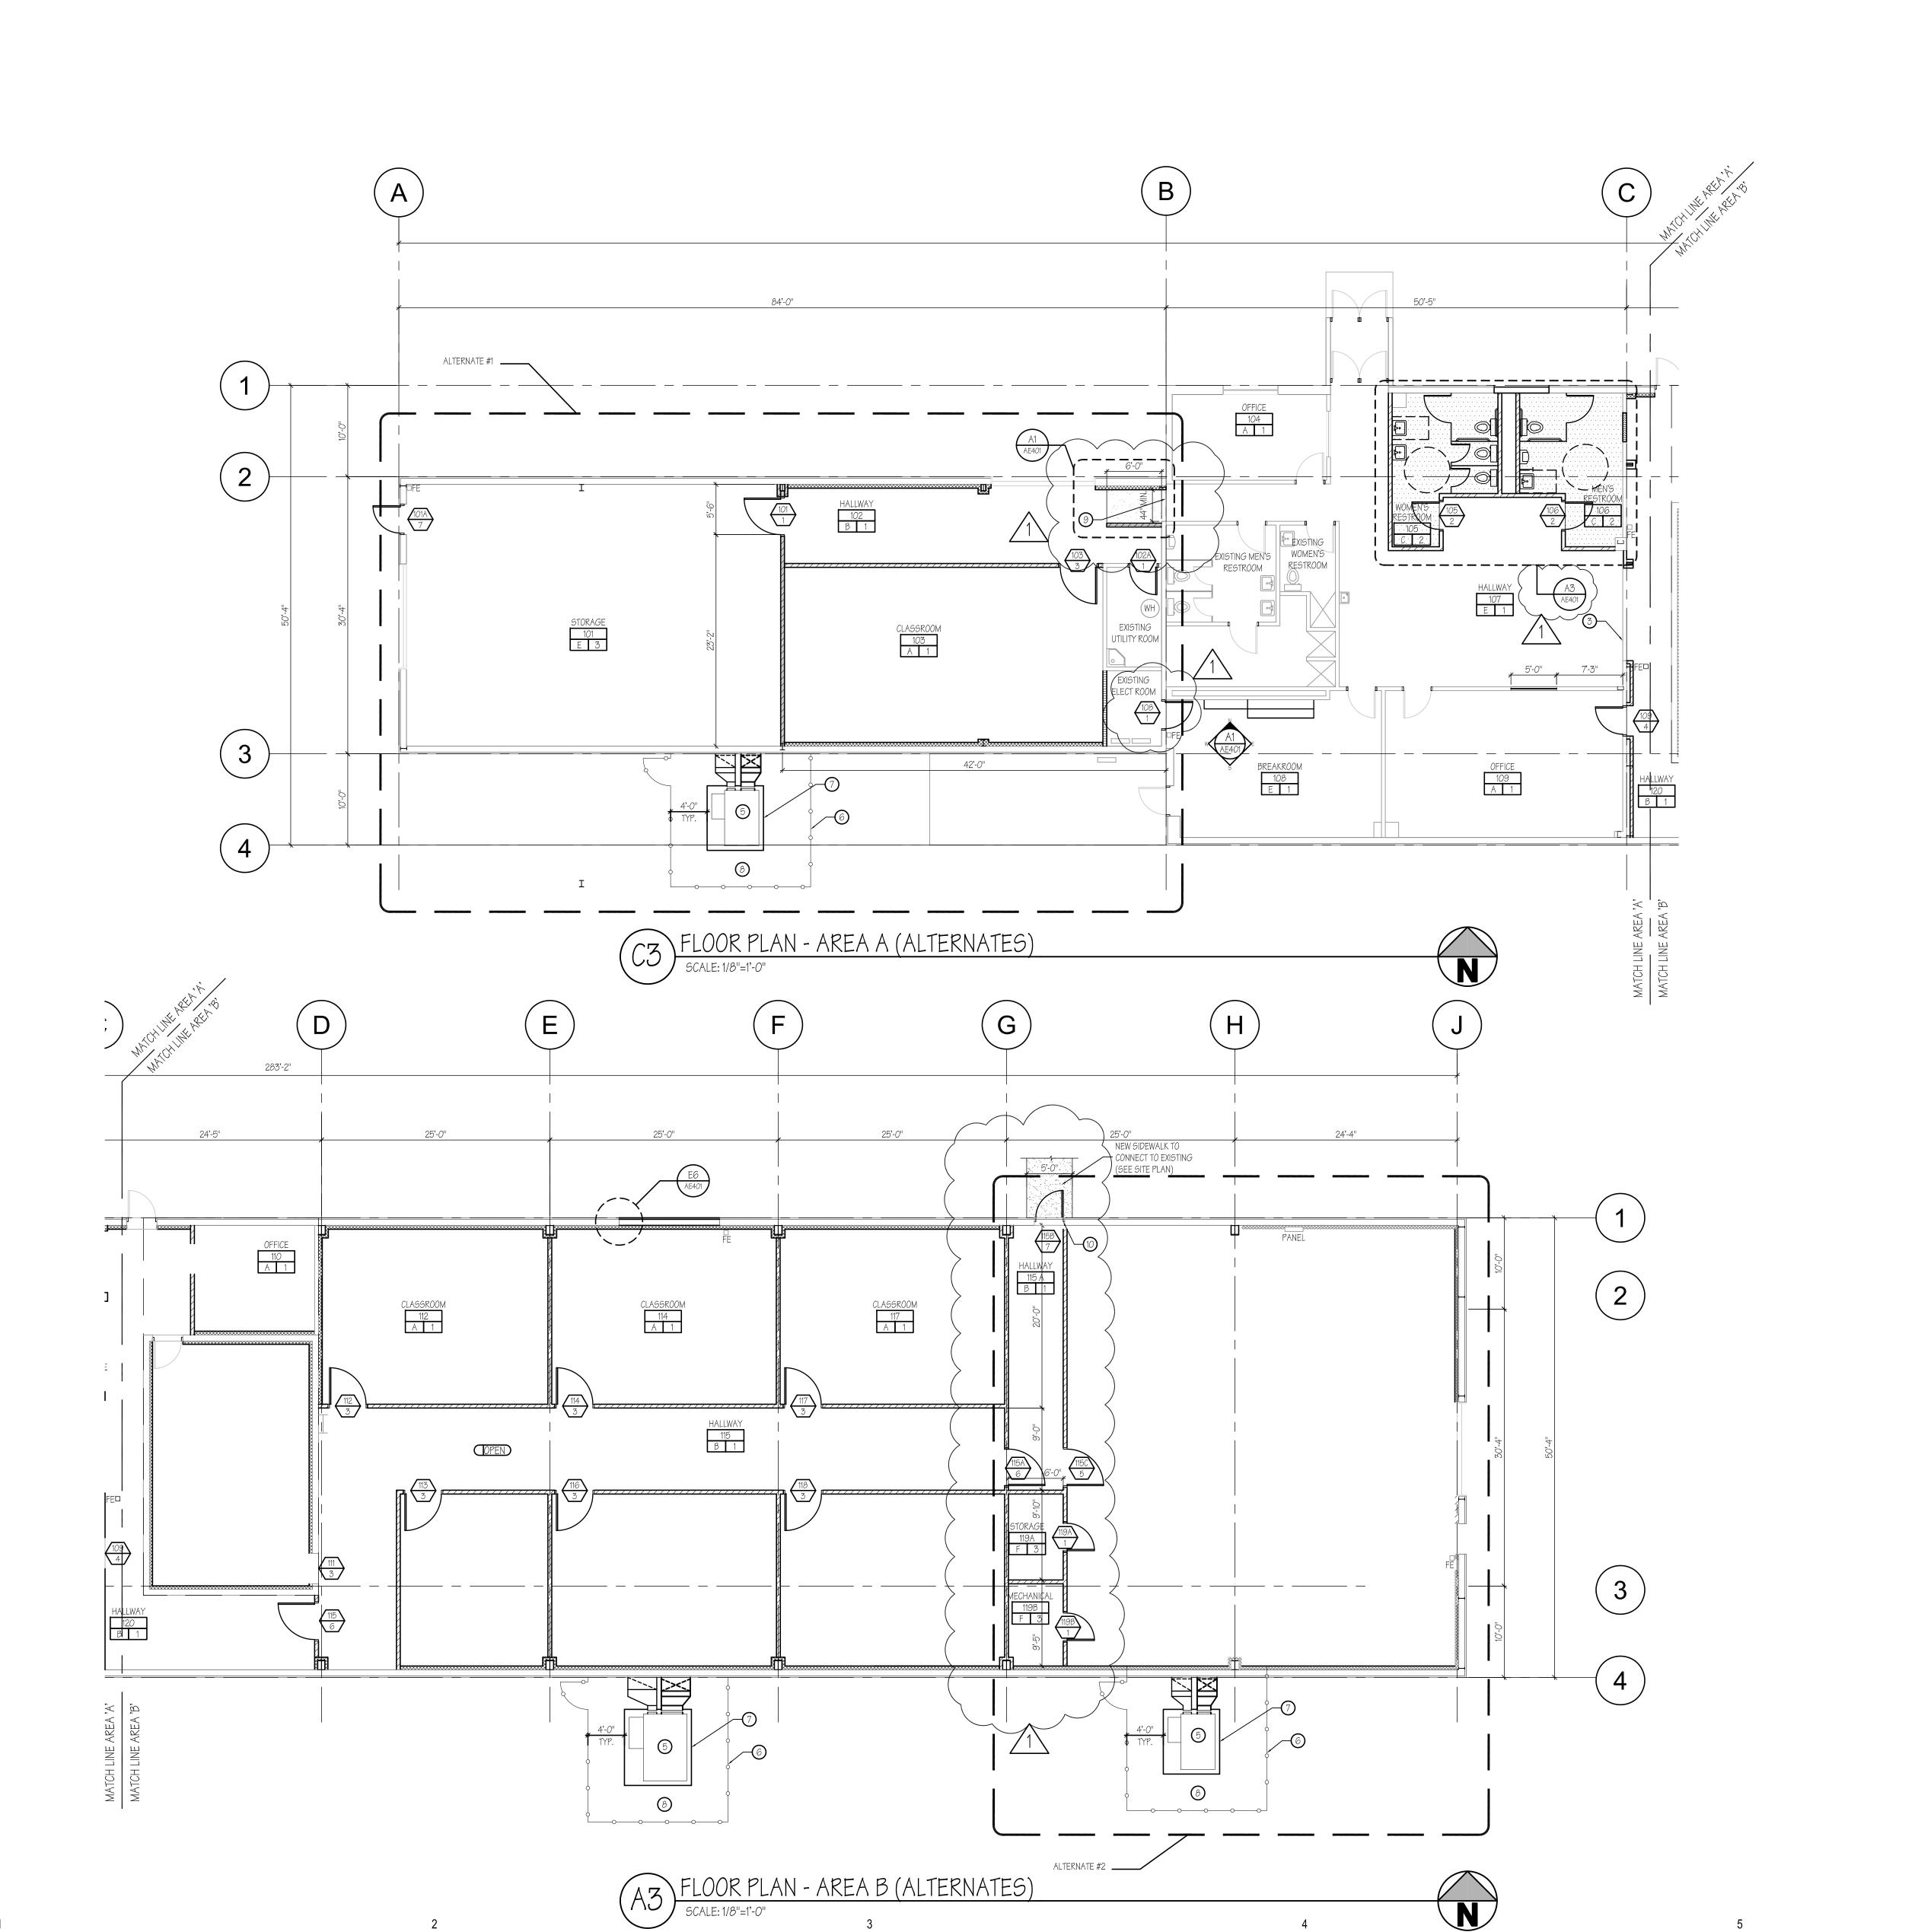

GENERAL NOTES

A. ALL DIMENSIONS TAKEN FROM GRID TO CENTER LINE OF WALL, UNLESS NOTED OTHERWISE. THE CURTAIN WAL SYSTEM DIMENSION ID FROM GRID TO THE FACE OF THE SYSTEM.

B. IF A CONFLICT OCCURS BETWEEN DRAWINGS, DRAWINGS AND SPECIFICATIONS, SPECIFICATION SECTIONS AND DIVISIONS OR BETWEEN OTHER PARTS OF THESE CONSTRUCTION DOCUMENTS OR THESE DOCUMENTS AND ANY CODE REQUIREMENT, THE CONTRACTOR MAY REQUEST CLARIFICATION DURING THE BIDDING PERIOD. OTHERWISE THE MOST STRINGENT REQUIREMENTS SHALL APPLY AND BE PART OF THE CONTRACT AT NO ADDITIONAL COST TO THE OWNER.

C. ALL WORK AND MATERIALS SHALL BE IN FULL CONFORMANCE WITH THE LATEST FEDERAL, STATE AND LOCAL CODES LAWS AND ORDINANCES. INCLUDING THEIR MOST RECENT REVISIONS, AMENDMENTS AND INTERPRETATIONS.

D. THE GENERAL CONTRACTOR SHALL BRING TO THE ATTENTION OF THE ARCHITECT, FOR IMMEDIATE RESOLUTION, ANY NON-CONFORMING CONDITIONS WHICH MAY BE FOUND IN EXISTING FIELD CONDITIONS. E. SEE MECHANICAL AND ELECTRICAL, DRAWINGS FOR ADDITIONAL INFORMATION AND COORDINATE.

WALL SCHEDULE

3-5/8" METAL FRAMING AT 16" O.C. W/ 5/8" GYPSUM BOARD SINGLE SIDE. EXTEND WALL 6" ABOVE CEILING. 1 HR. RATED ASSEMBLY. 3-5/8" METAL FRAMING @ 16" O.C. WITH TYPE "X" 5/8" GYPSUM BOARD EACH SIDE. EXTEND TO DECK ABOVE. SEAL ALL PENETRATIONS.

> WALL TO UNDERSIDE OF ROOF DECK OR STRUCTURE. EXTEND GYPSUM BOARD 6" ABOVE CEILING. SEE DETAIL D6/AE401. NOTE: AT GRID "G" EXTEND GYPSUM BOARD TO UNDERSIDE OF STRUCTURE ALONG EAST SIDE.

3-5/8" METAL FRAMING AT 16" O.C. W/ 5/8" GYPSUM BOARD EACH SIDE. EXTEND

3-5/8" METAL FRAMING AT 16" O.C. W/ 5/8" GYPSUM BOARD EACH SIDE. EXTEND WALL TO UNDERSIDE OF ROOF DECK OR STRUCTURE. EXTEND GYPSUM BOARD 6" ABOVE CEILING. PROVIDE SOUND BATT INSULATION. SEE DETAIL D6/AE401 3-5/8" METAL FRAMING AT 16" O.C. W/ 5/8" GYPSUM BOARD BOTH SIDES AND TOP @ 3'-6" AFF. SEE (ALTERNATE #1). PROVIDE (1) 3"x3"x/4" TUBE STEEL WITH BASE

PLATE AND (2) % AB. LOCATE AT THE END OF THE WALL.

3-5/8" METAL FRAMING AT 16" O.C. W/ 5/8" GYPSUM BOARD EACH SIDE. EXTEND WALL AND GYPSUM BOARD UP TO DECK. SEE DETAIL D6/AE401.

3-5/8" METAL FRAMING AT 16" O.C. W/ 5/8" GYPSUM BOARD SINGLE SIDE. INFILL EXISTING OPENING COMPLETE. AT RESTROOM 106, PROVIDE GYP. BD. EACH SIDE.

3-5/8" METAL FRAMING AT 16" O.C. W/ 5/8" GYPSUM BOARD SINGLE SIDE. EXTEND WALL AND GYPSUM BOARD TO UNDERSIDE OF ROOF DECK OR STRUCTURE. (ALTERNATE #2)

FINISH SCHEDULE

FLOOR/BASE FINISH A 2 WALL/FINISH			
FLOOR / BASE	WALL / WAINSCOT		
A. CARPET TILE W/ RUBBER BASE .	1. PAINTED GYPSUM BOARD.		
B. VINYL COMPOSITION TILE (VCT) W/ COVED RUBBER BASE.	2. CERAMIC TILE WSCT ON WET WALL. GYPSUM BOARD & EPOXY PAINT ON ALL OTHER WALLS.		
C. CERAMIC MOSAIC TILE W/ TILE BASE.	3. EXISTING.		
D. WALK-OFF CARPET.			
E. EXISTING VCT & RUBBER BASE, CLEAN & WAX.			
F. EXISTING CONCRETE.			

LEGEND

RECESSED FLOOR SLAB. SEE FLOOR FINISHES FOR ADDITIONAL INFORMATION.
CONCRETE FOR NEW LANDING (BASE BID) OR RAMP (ALTERNATE # MAXIMUM SLOPE 1:12.

KEYED NOTES

EXISTING FIRE EXTINGUISHER

PAINT EXISTING DOOR AND FRAME.

RELOCATED WINDOW, SILL HEIGHT TO MATCH EXISTING, PAINT FRAME. (3) EDGE OF EXISTING VCT TILE.

EXISTING WALL MOUNTED ACCESS LADDER TO MECHANICAL MEZZANINE, PAINT.

NEW MECHANICAL UNIT. SEE MECHANICAL DRAWINGS FOR ADDITIONAL INFORMATION. 6) CHAIN LINK FENCE WITH 3'-0" GATE.

4" CONCRETE PAD OVER GRANULAR BASE. COORDINATE SIZE WITH MECHANICAL UNIT.

6" GRANULAR MATERIAL OVER LANDSCAPE FILTER FABRIC.

PROVIDE 3 #4 DOWELS BY 12" OC. 6" EMBED EACH WAY. PROVIDE 4X4 STEEL ANGLE AND PLATE TO EACH JAMB. SIZE PLATE ACCORDINGLY. WELD TO STEEL ANGLE AND UPPER HORIZONTAL WIND GIRT AND ANCHOR TO FOUNDATION. SEE DETAIL,

AREA A

(A6) KEY PLAN

SCALE: 1/600"=1'-0"

NTERIORS **P**LANNING

CONSULTANT

1484 South State Street Salt Lake City, Utah 84115 801-596-0691/F: 596-0693 www.hfsa.com

CAMP WILLIAMS BLDG. 1830 REMODEL UTAH NATIONAL GUARD

MARK DATE DESCRIPTION 7-21-2008 DFCM REVIEW COMMENTS

June 19, 2008 08021480 PROJECT NO: 0763.01 HFSA PROJECT NO: CAD DWG FILE NO: DRAWN BY: CHECKED BY: DESIGNED BY: Architectural DWG TYPE: ARCHITECTURAL PHASE:


Construction Documents


FLOOR PLAN ALTERNATES


AREA B




SHEET

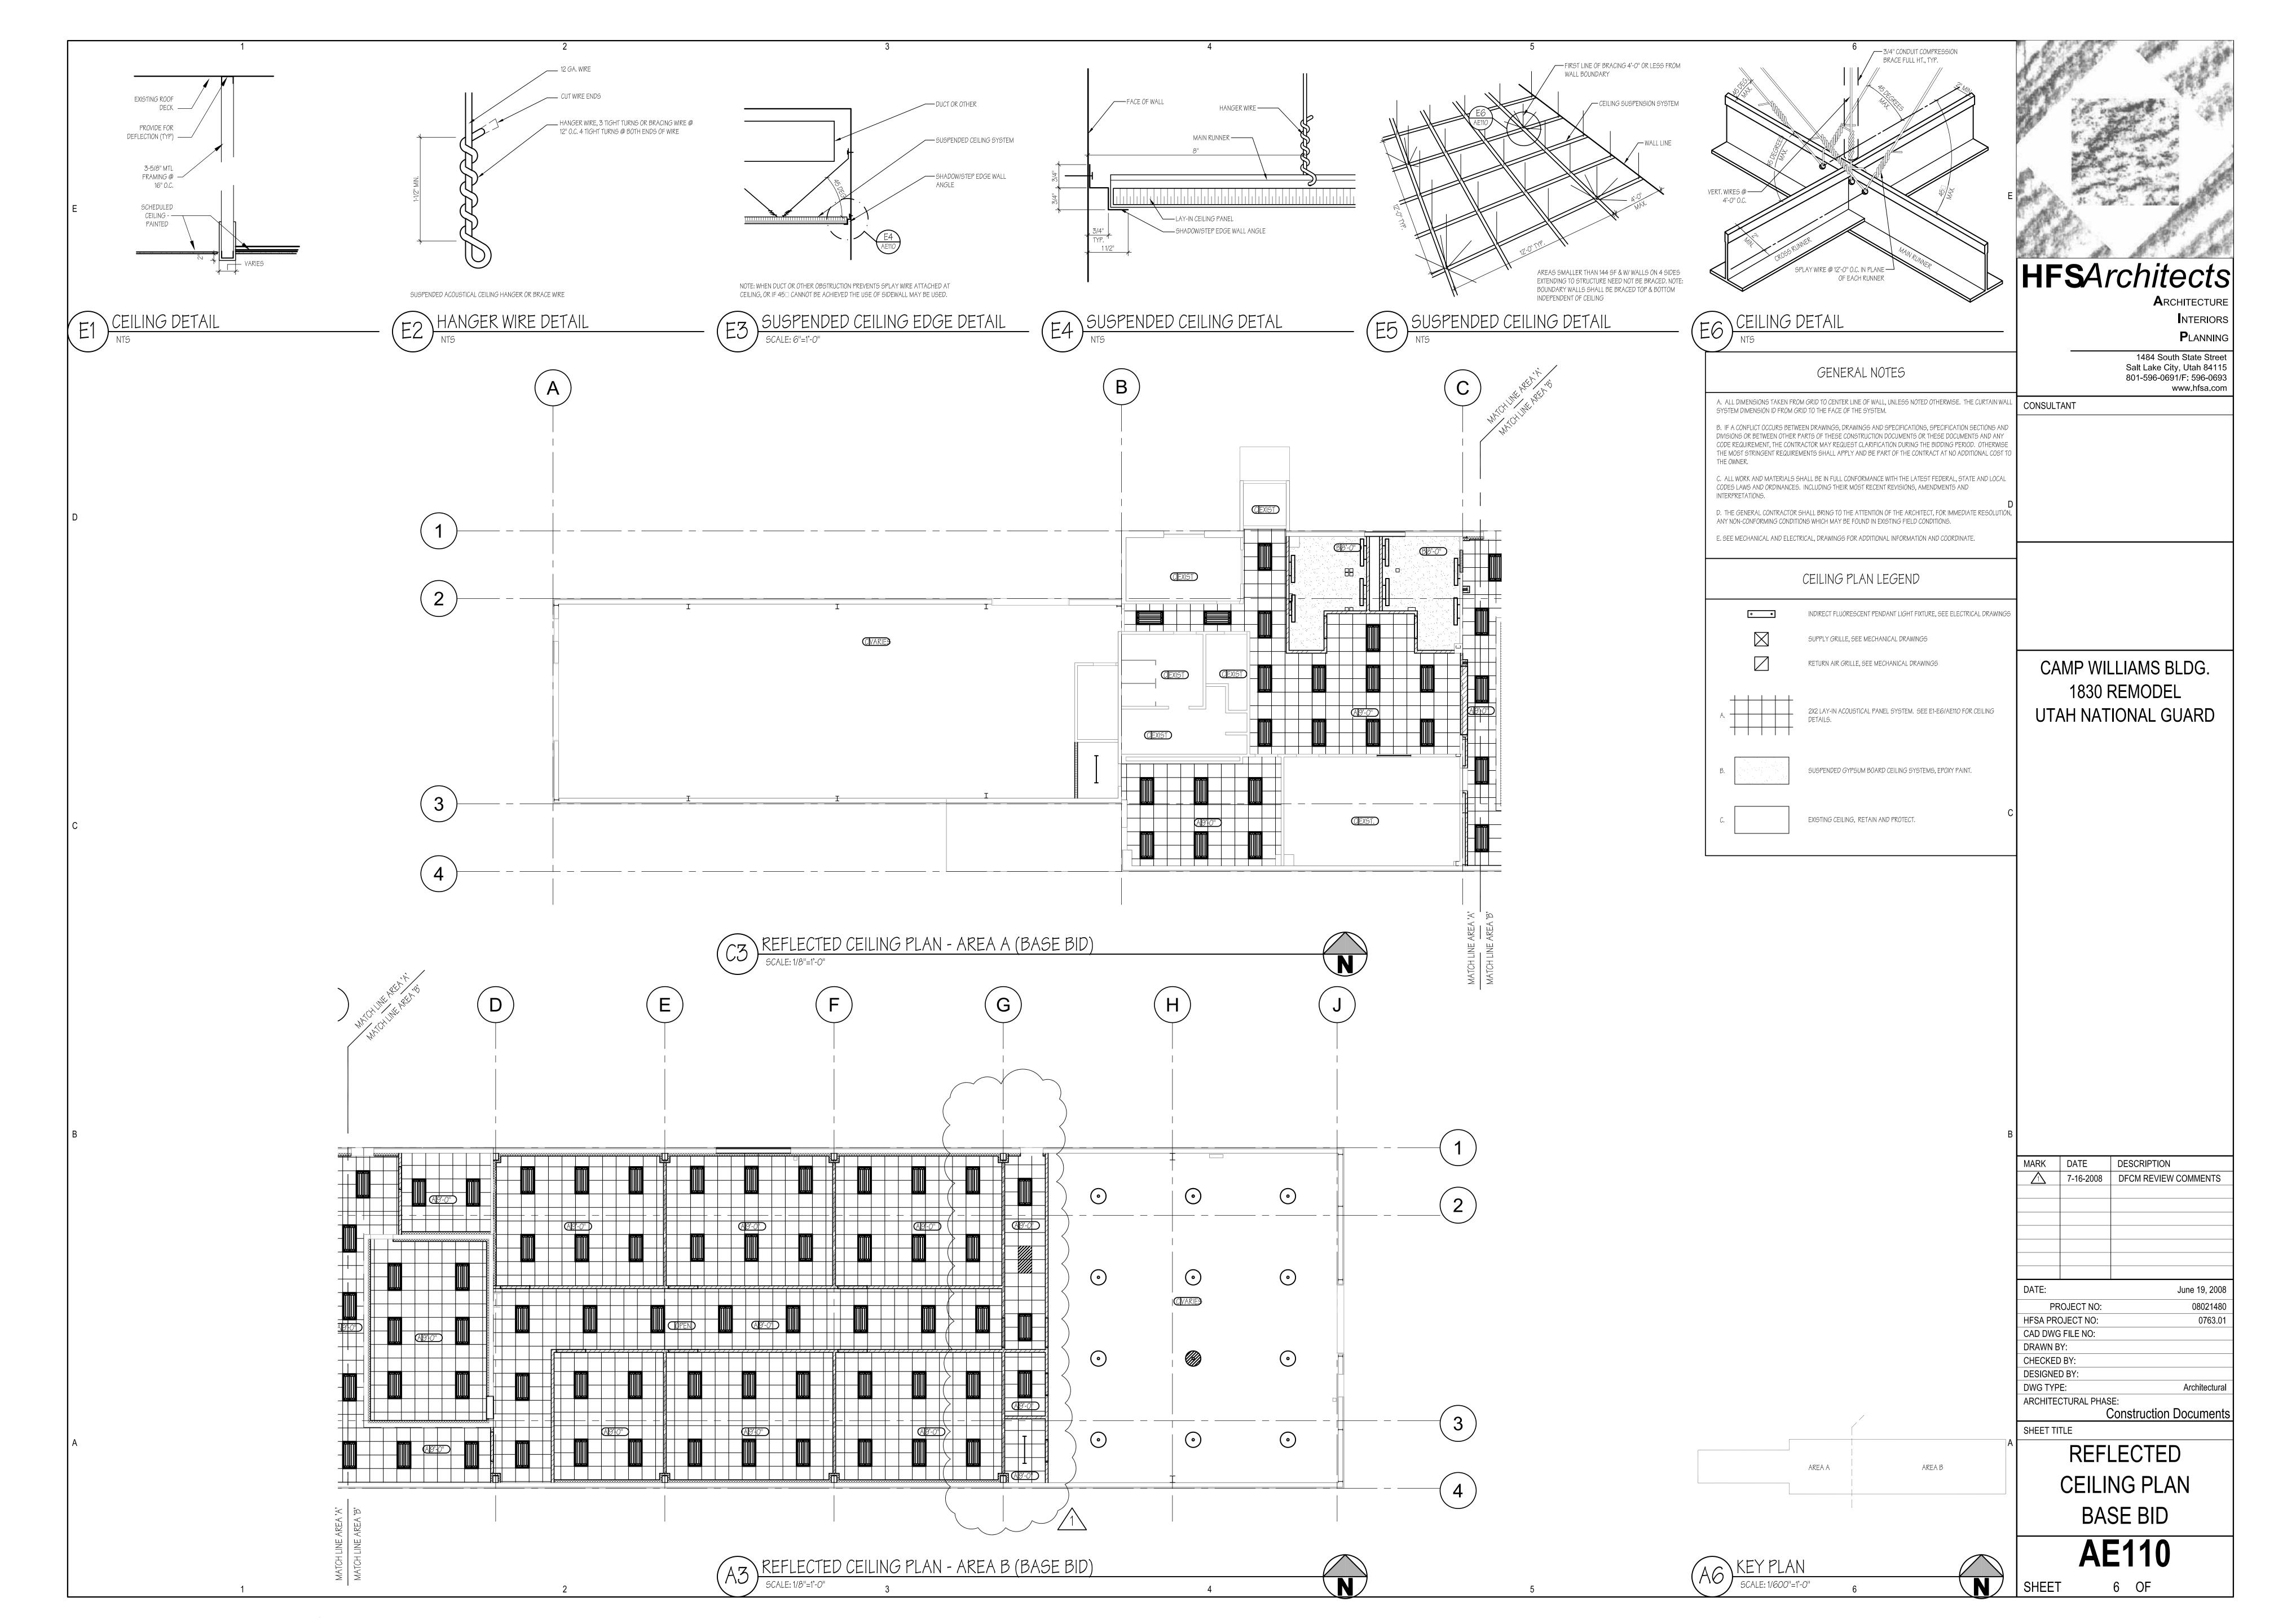

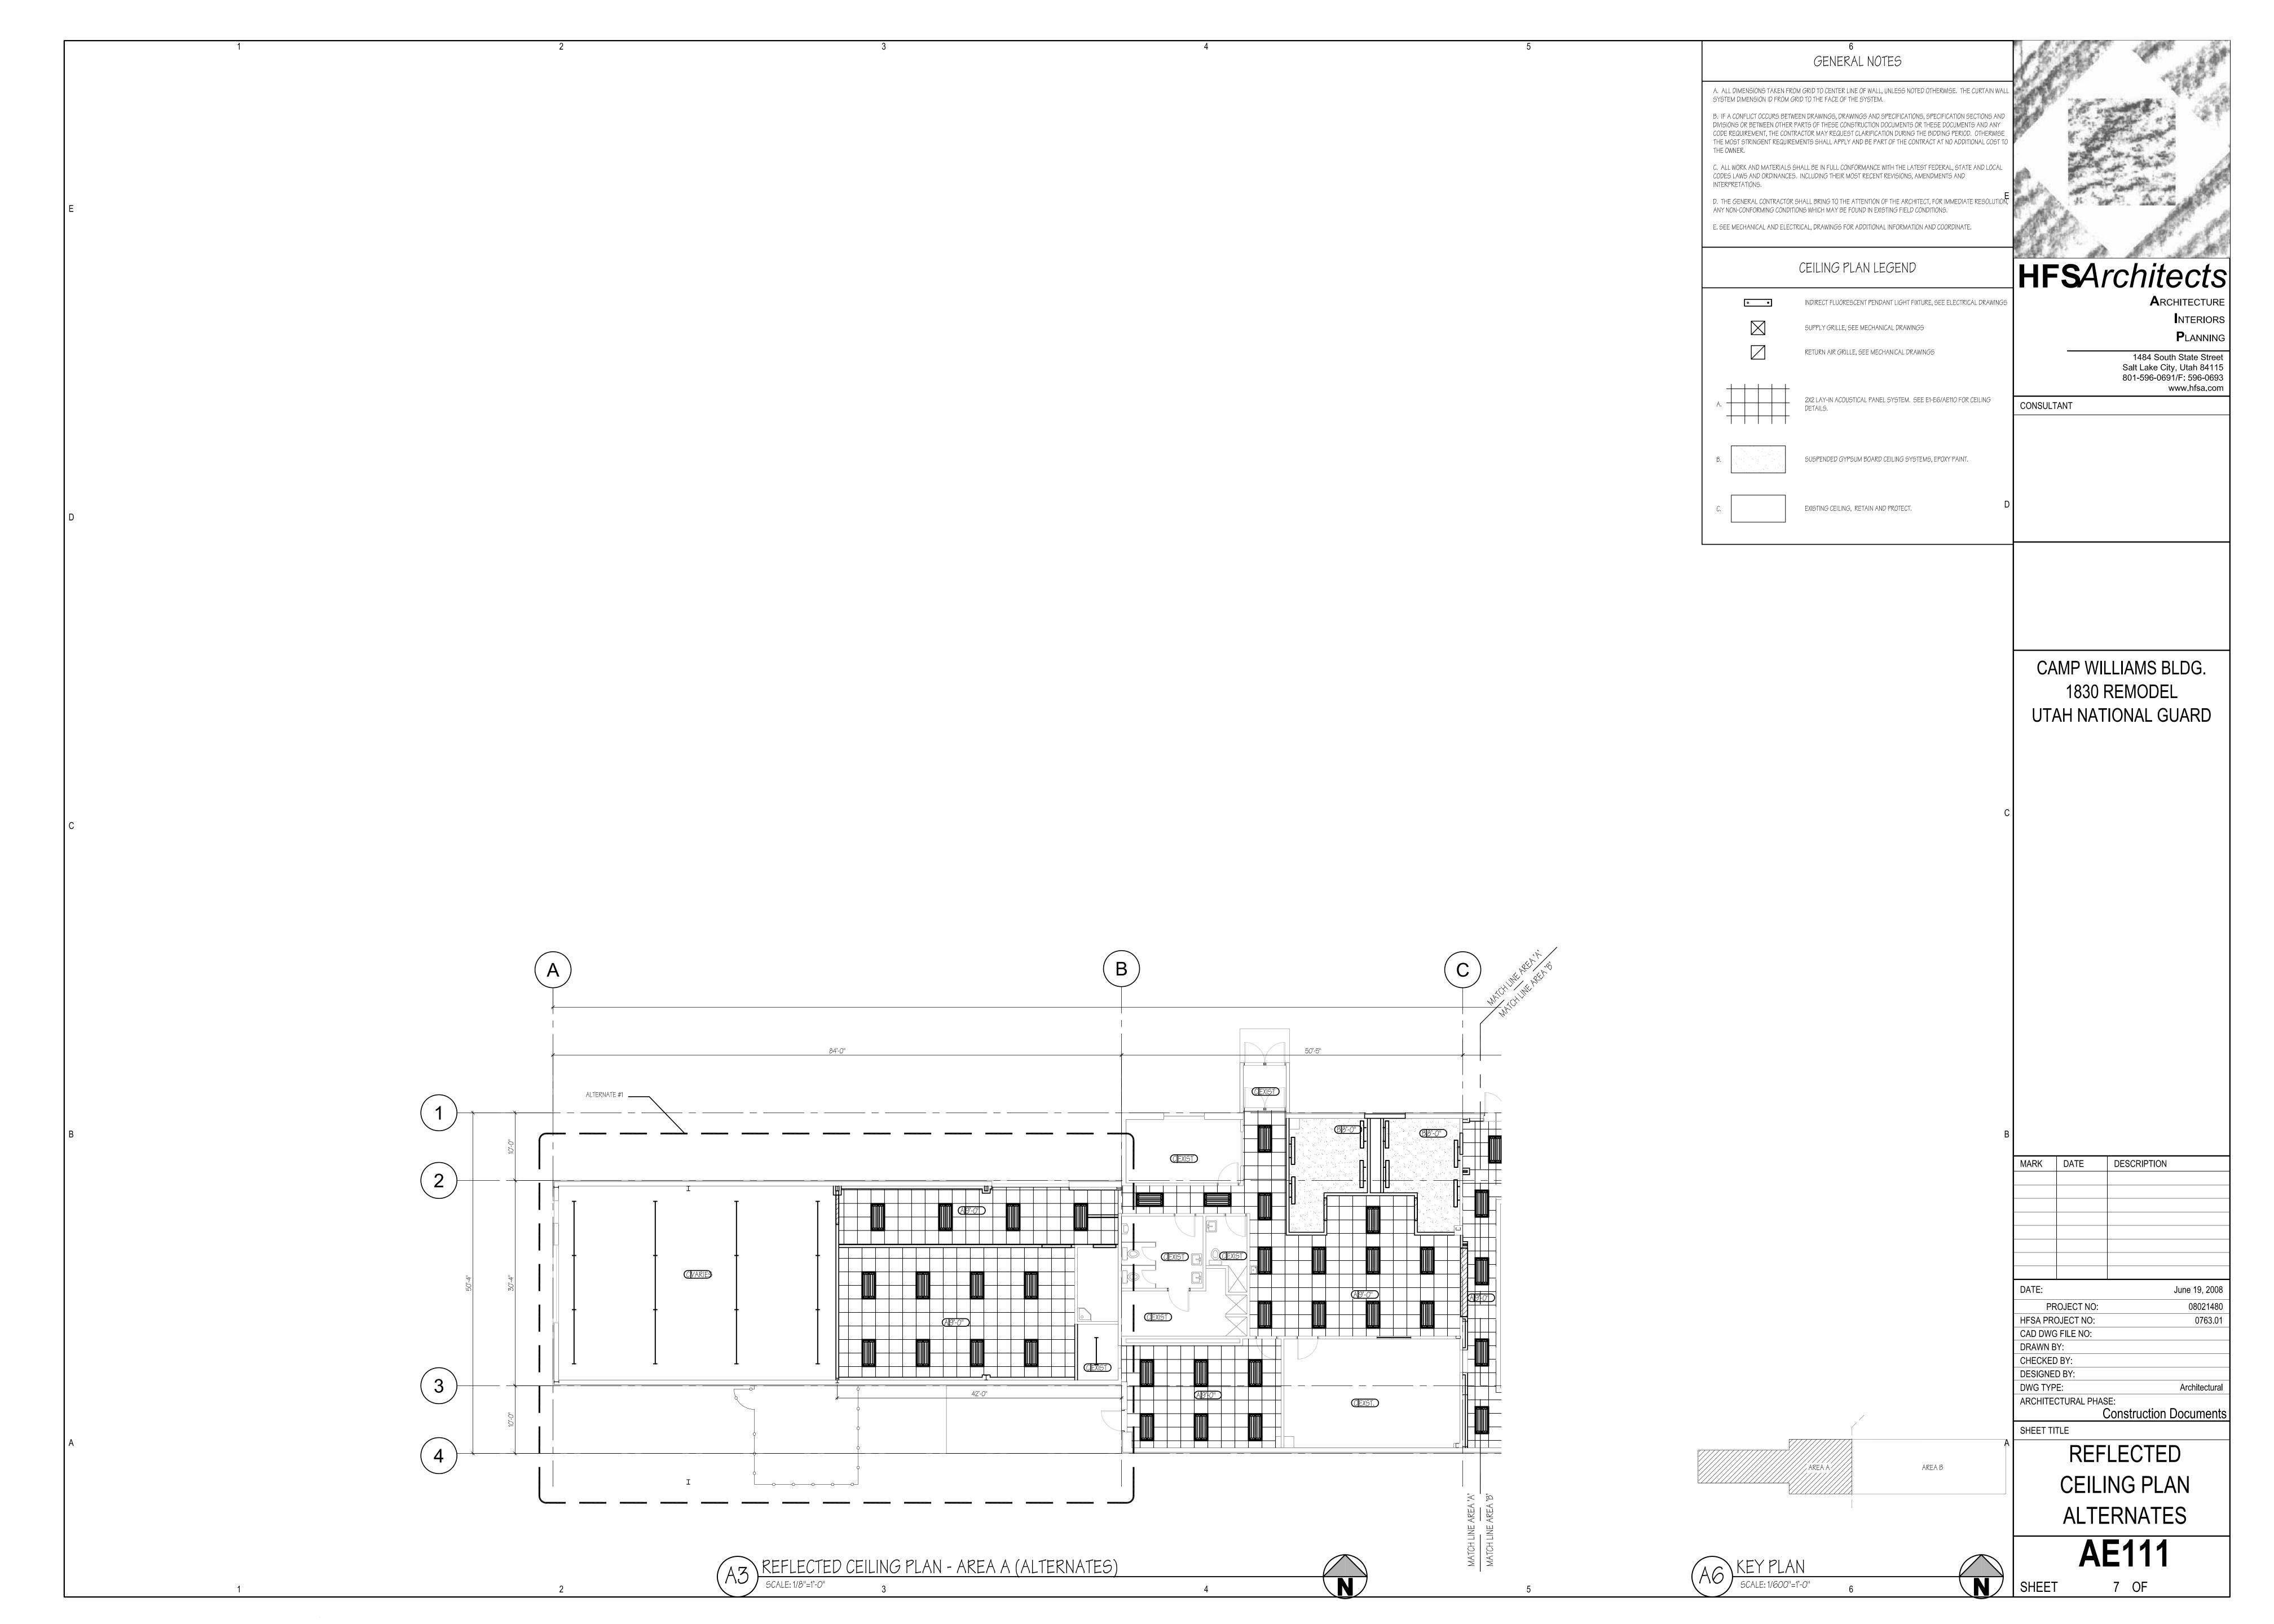

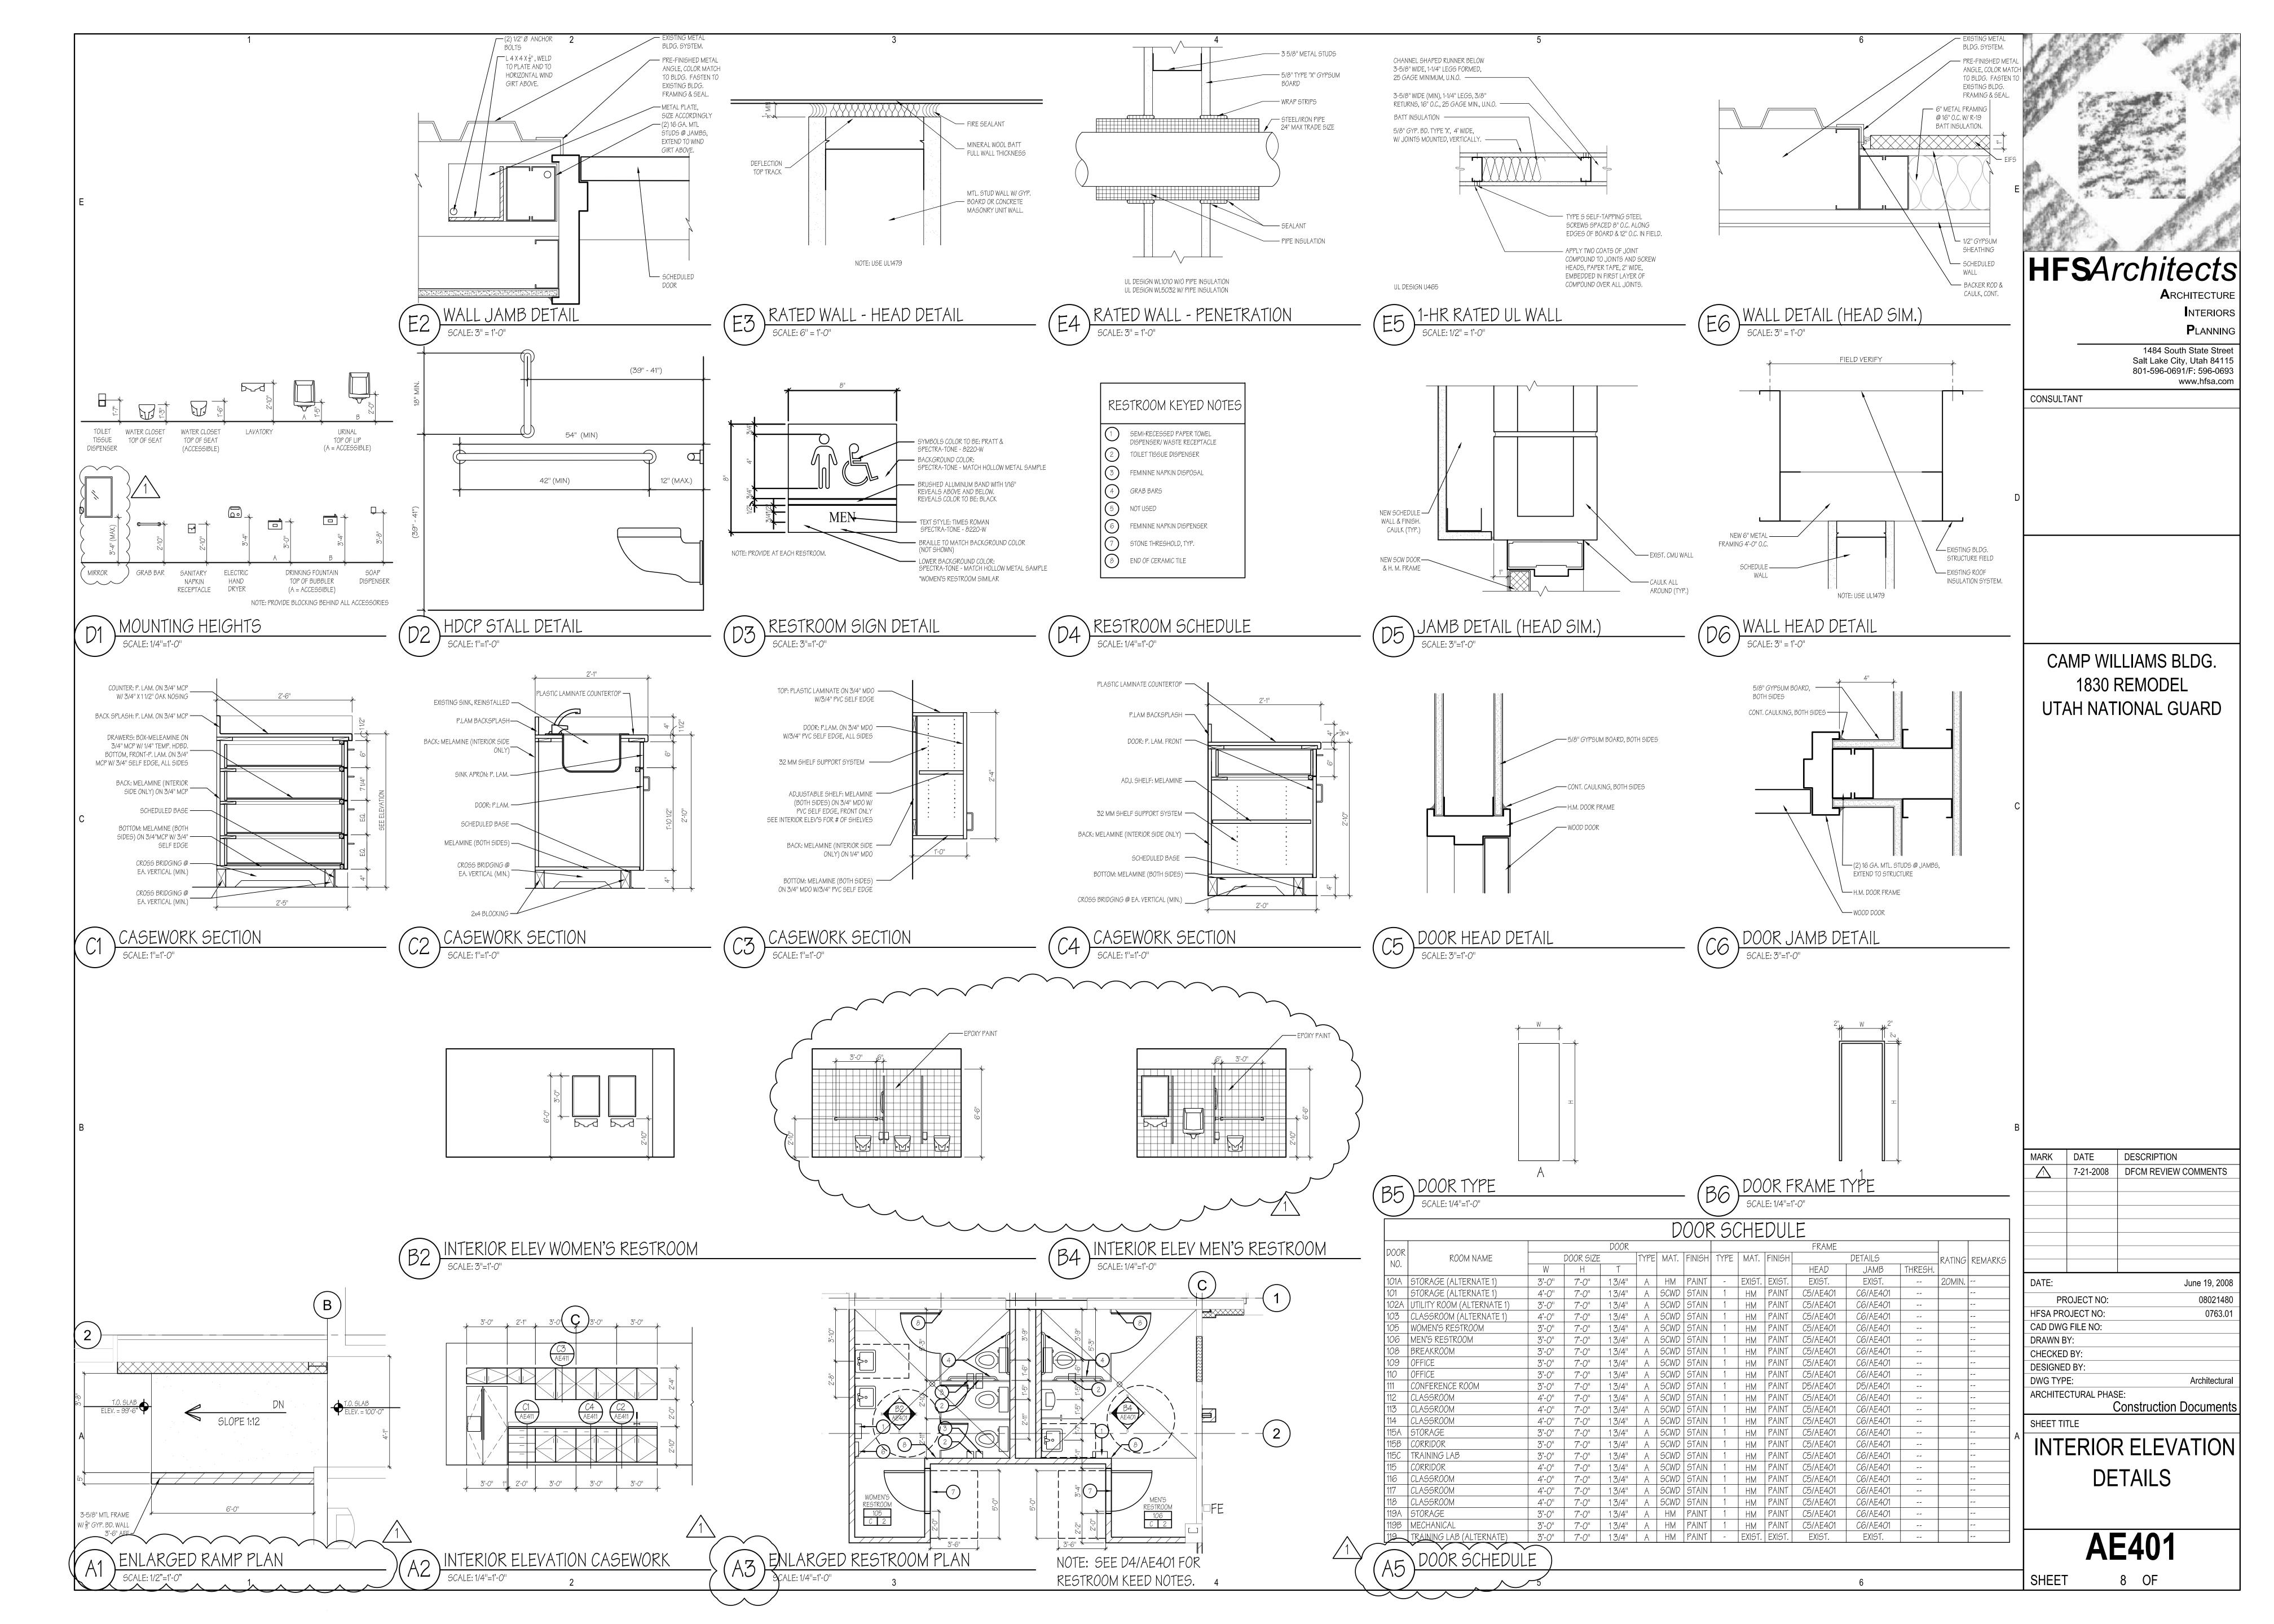

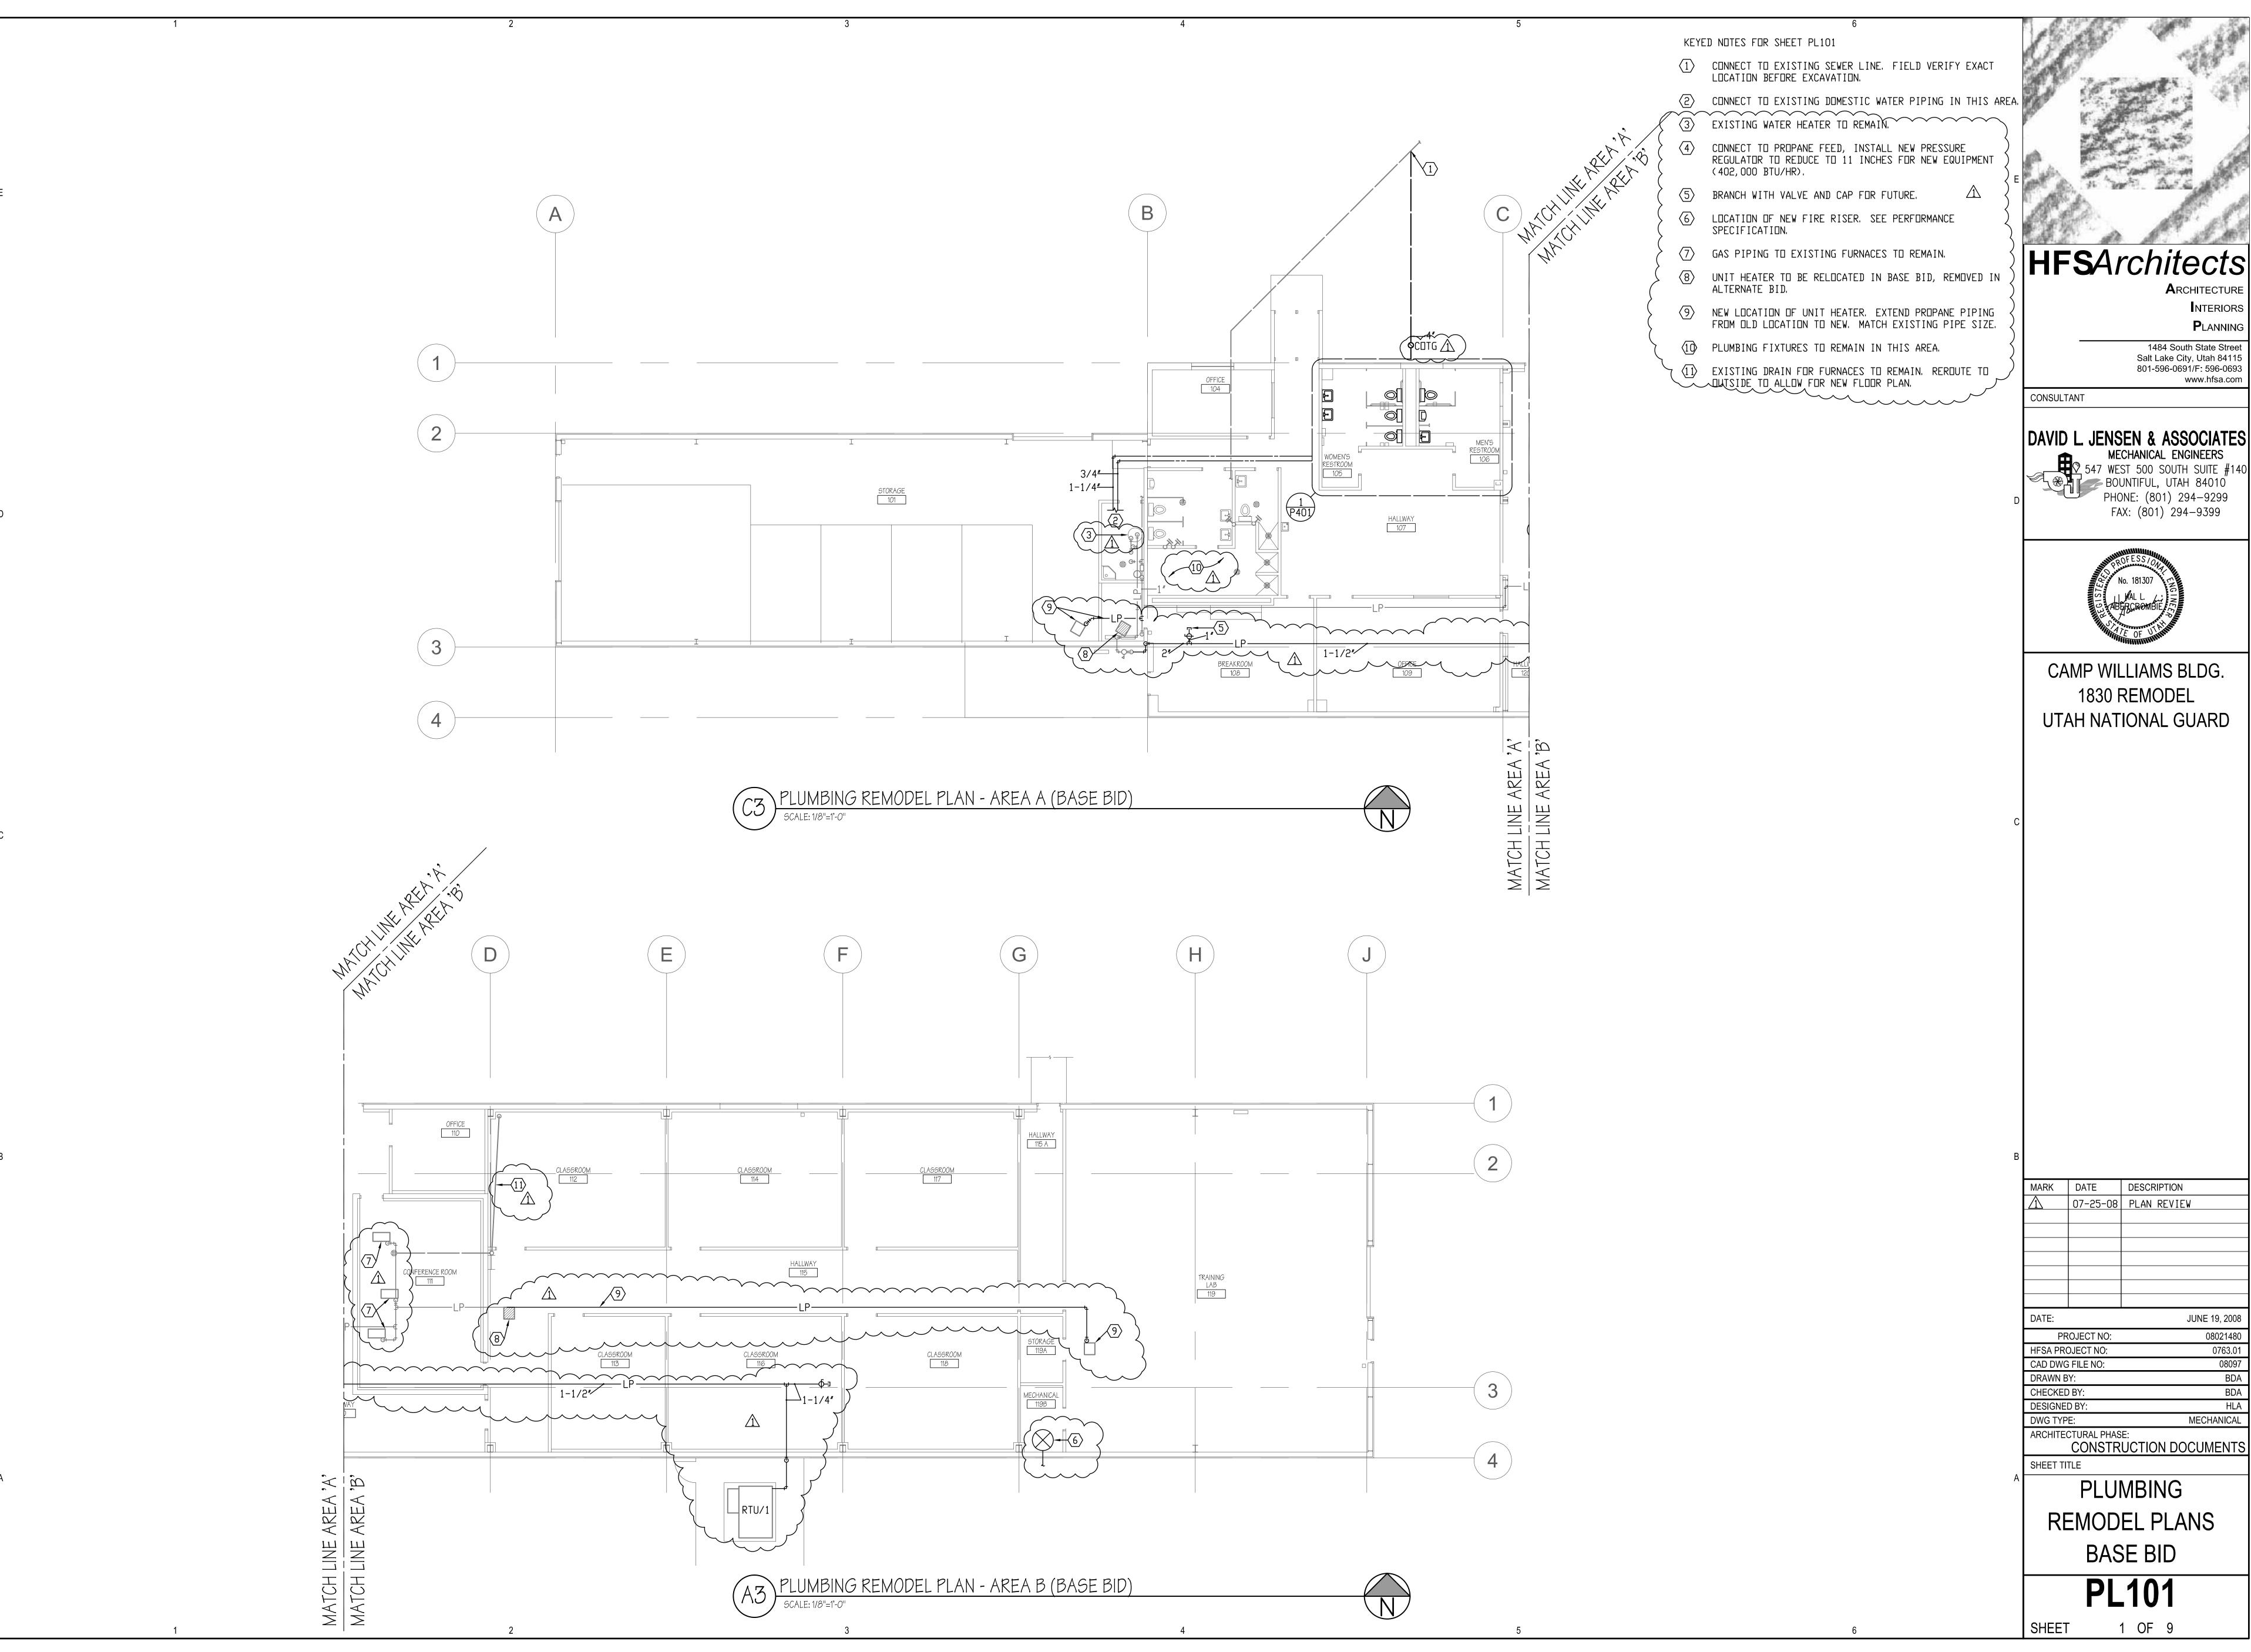


INTERIORS **P**LANNING

Salt Lake City, Utah 84115 801-596-0691/F: 596-0693

DAVID L. JENSEN & ASSOCIATES


PHONE: (801) 294-9299 FAX: (801) 294-9399

DATE:	JUNE 19, 2008
PROJECT NO:	08021480
HFSA PROJECT NO:	0763.01
CAD DWG FILE NO:	08097
DRAWN BY:	BDA
CHECKED BY:	BDA
DESIGNED BY:	HLA
DWG TYPE:	MECHANICAL
ADCHITECTUDAL DHASE:	

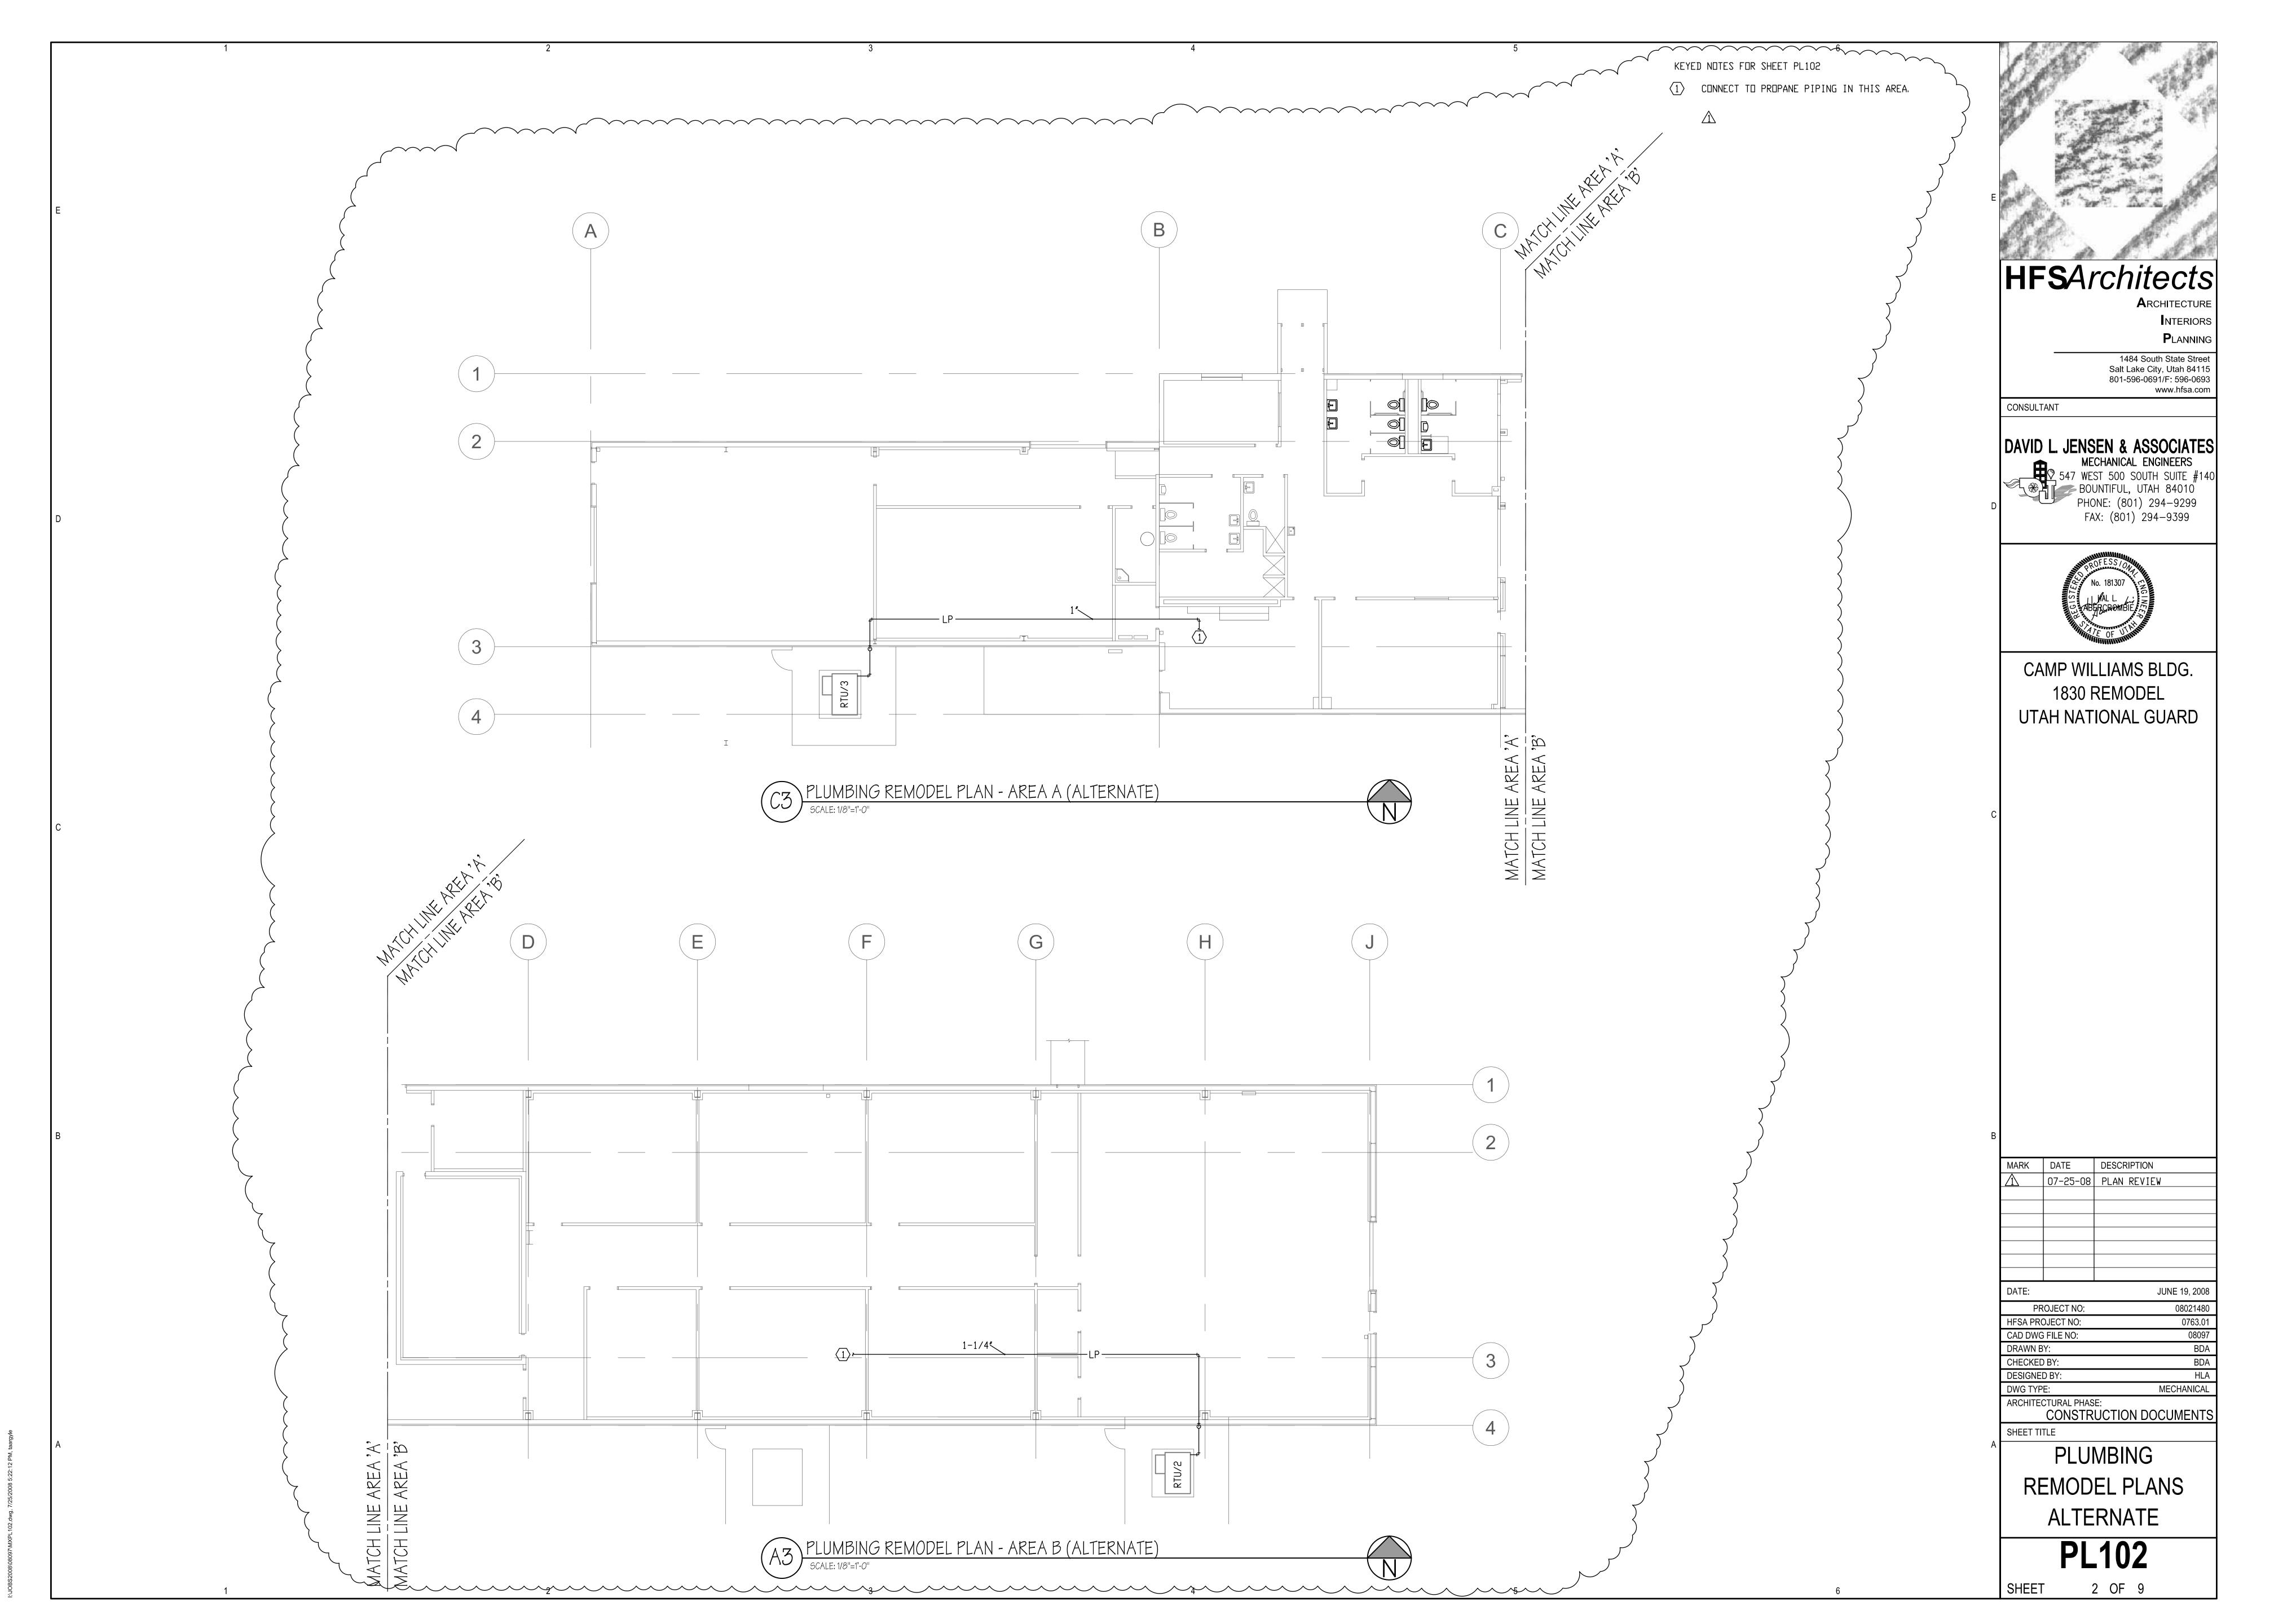


KEYED NOTES FOR SHEET P401

1 ISOLATION VALVES IN CEILING SPACE.

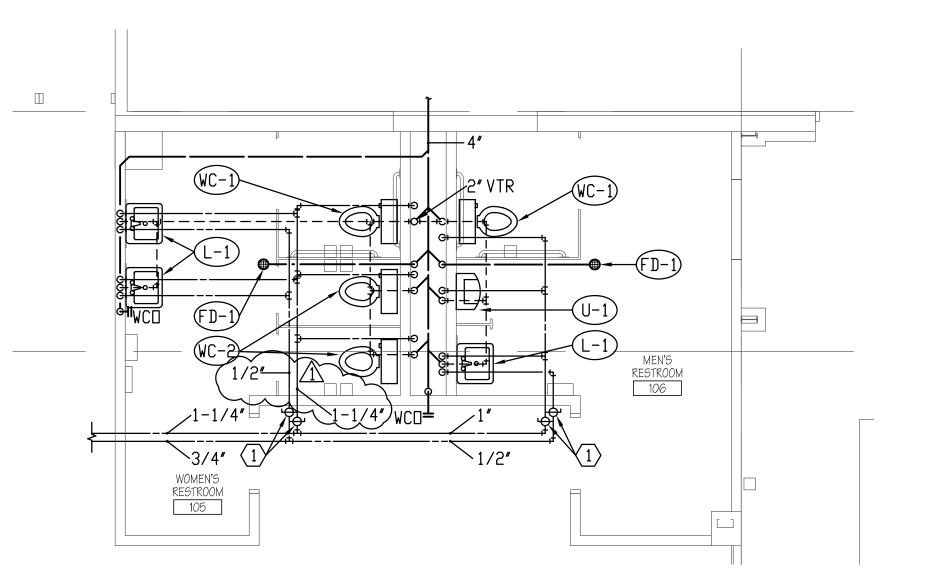

LARGE SCALE RESTROOM REMODEL PLAN

SCALE 1/4"=1'-0"

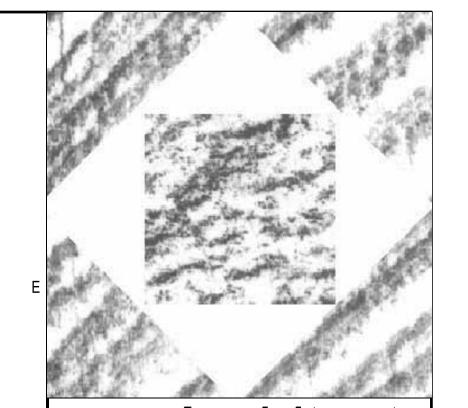

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ARCHITECTURE NTERIORS **P**LANNING

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CONSULTANT

DAVID L. JENSEN & ASSOCIATES


MECHANICAL ENGINEERS

547 WEST 500 SOUTH SUITE #140

BOUNTIFUL, UTAH 84010

PHONE: (801) 294–9299

FAX: (801) 294–9399

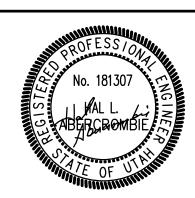

CAMP WILLIAMS BLDG. 1830 REMODEL UTAH NATIONAL GUARD

MARK DATE DESCRIPTION 1 07-25-08 PLAN REVIEW

JUNE 19, 2008 PROJECT NO: 08021480 0763.01 08097 BDA HFSA PROJECT NO: CAD DWG FILE NO: DRAWN BY: CHECKED BY: DESIGNED BY:

DWG TYPE: MECHANICAL

ARCHITECTURAL PHASE:

CONSTRUCTION DOCUMENTS SHEET TITLE

> PLUMBING LARGE SCALE PLAN


> > P401


3 OF 9 SHEET


	PLUMBING FIXTURE SCHEDULE						
SYMBOL	FIXTURE	TRAP	WASTE	VENT	H. W.	C. W.	DESCRIPTION
(-1)	LAVATORY (ADA)	1-1/4"	1-1/2"	1-1/4"	1/2"	1/2"	WALL MOUNT ①
WC-1)	WATER CLOSET (ADA)	INT	4"	2"	-	1/2"	FLUSH TANK
(MC-5)	WATER CLOSET	INT	4"	2"	-	1/2"	FLUSH TANK
(FD-1)	FLOOR DRAIN	2"	2"	2"	-	_	PROVIDE WITH TRAP PRIMER
<u>U-1</u>	URINAL	INT	3″	2"	-	3/4"	

① PROVIDE WITH TEMPERING VALVE.

HOT WATER LINE	
COLD WATER LINE	
HOT WATER RECIRCULATION LINE	
VENT LINE	
WASTE LINE (ABOVE GRADE OR FLOOR)	
WASTE LINE (BELOW GRADE OR FLOOR)	
GREASE WASTE LINE	GW
GAS LINE	
COMPRESSED AIR LINE	A
OXYGEN LINE	0-
VACUUM LINE	V
DEIONIZED WATER LINE	DI
DRAIN LINE	D
VENT THRU ROOF	VTR
WALL CLEAN OUT	WCO
CLEAN OUT	CO
CLEAN OUT TO GRADE	COTG
FLOOR CLEAN OUT	FCO
BALL VALVE	Ф
GATE VALVE	——————————————————————————————————————
UNION	
GAS COCK VALVE	
PRESSURE REGULATOR	<u></u>
DROP	— ю
RISE	
ROOF DRAIN (ABOVE GRADE OR FLOOR)	RD
ROOF DRAIN (BELOW GRADE OR FLOOR)	
SECONDARY ROOF DRAIN	SRD

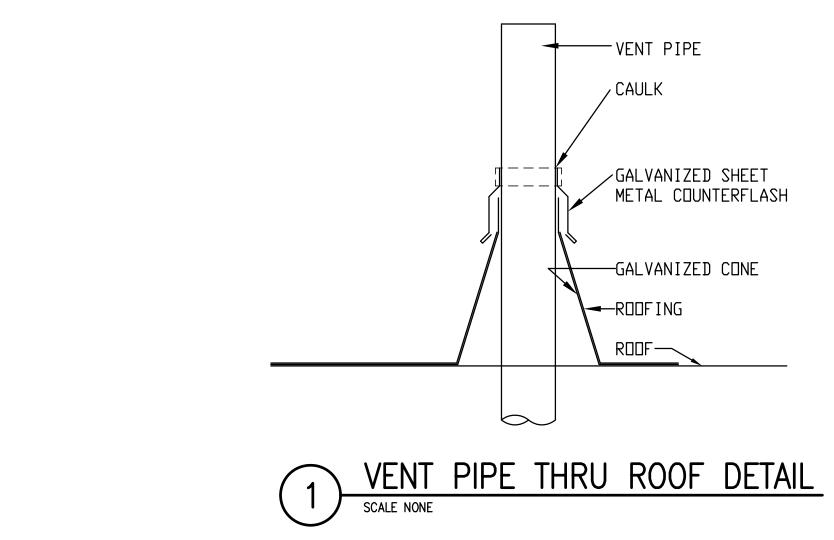

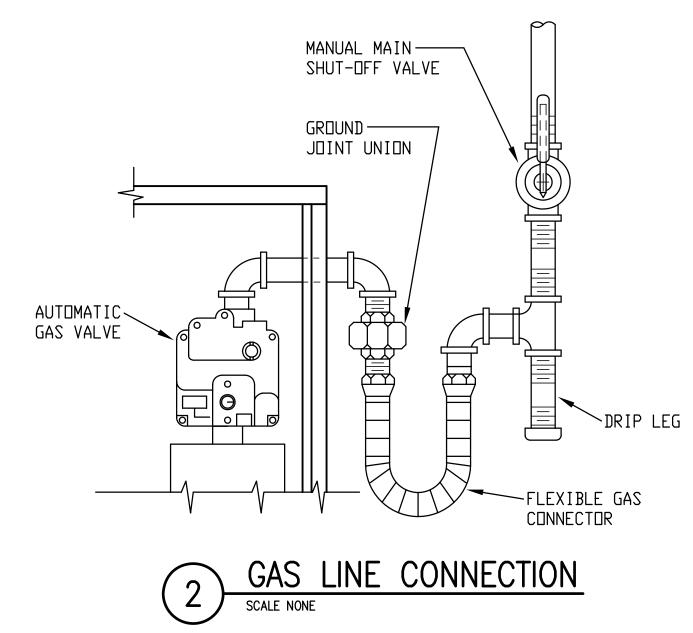

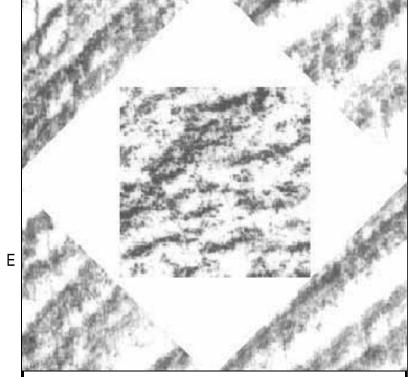


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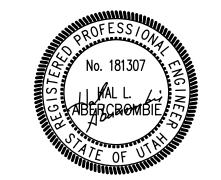
ARCHITECTURE NTERIORS **P**LANNING

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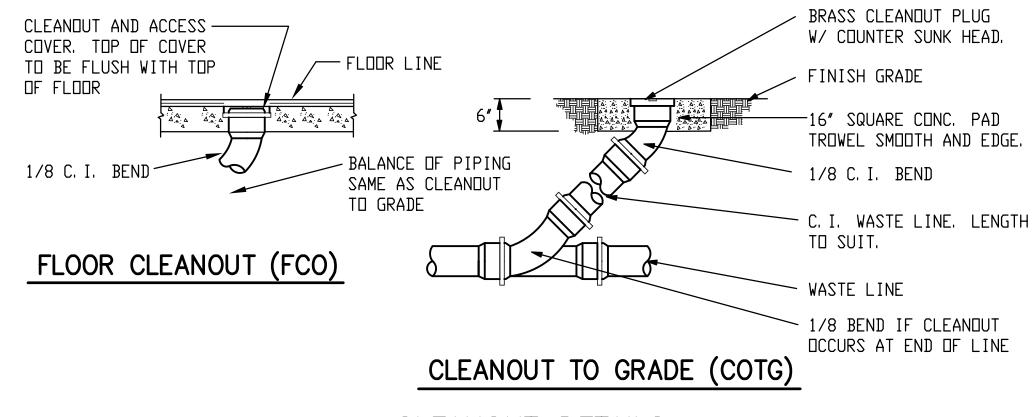
CONSULTANT

DAVID L. JENSEN & ASSOCIATES MECHANICAL ENGINEERS 547 WEST 500 SOUTH SUITE #140 BOUNTIFUL, UTAH 84010 PHONE: (801) 294-9299 FAX: (801) 294-9399




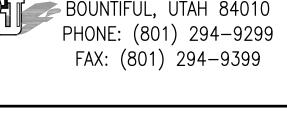

CAMP WILLIAMS BLDG. 1830 REMODEL UTAH NATIONAL GUARD



3 CLEANOUT DETAILS
SCALE NONE

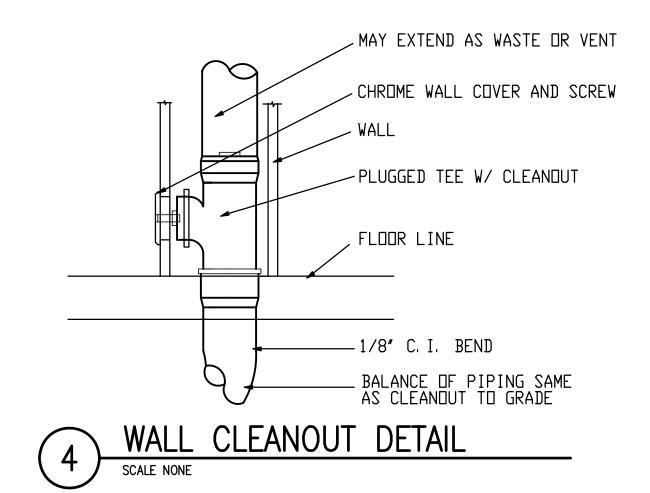


MARK	DATE	DESCRIPTION

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DWG TYPE:	MECHANICAL
ARCHITECTURAL PHAS	E:


CONSTRUCTION DOCUMENTS SHEET TITLE

PLUMBING DETAILS, LEGEND & SCHEDULE

P501 4 OF 9 SHEET

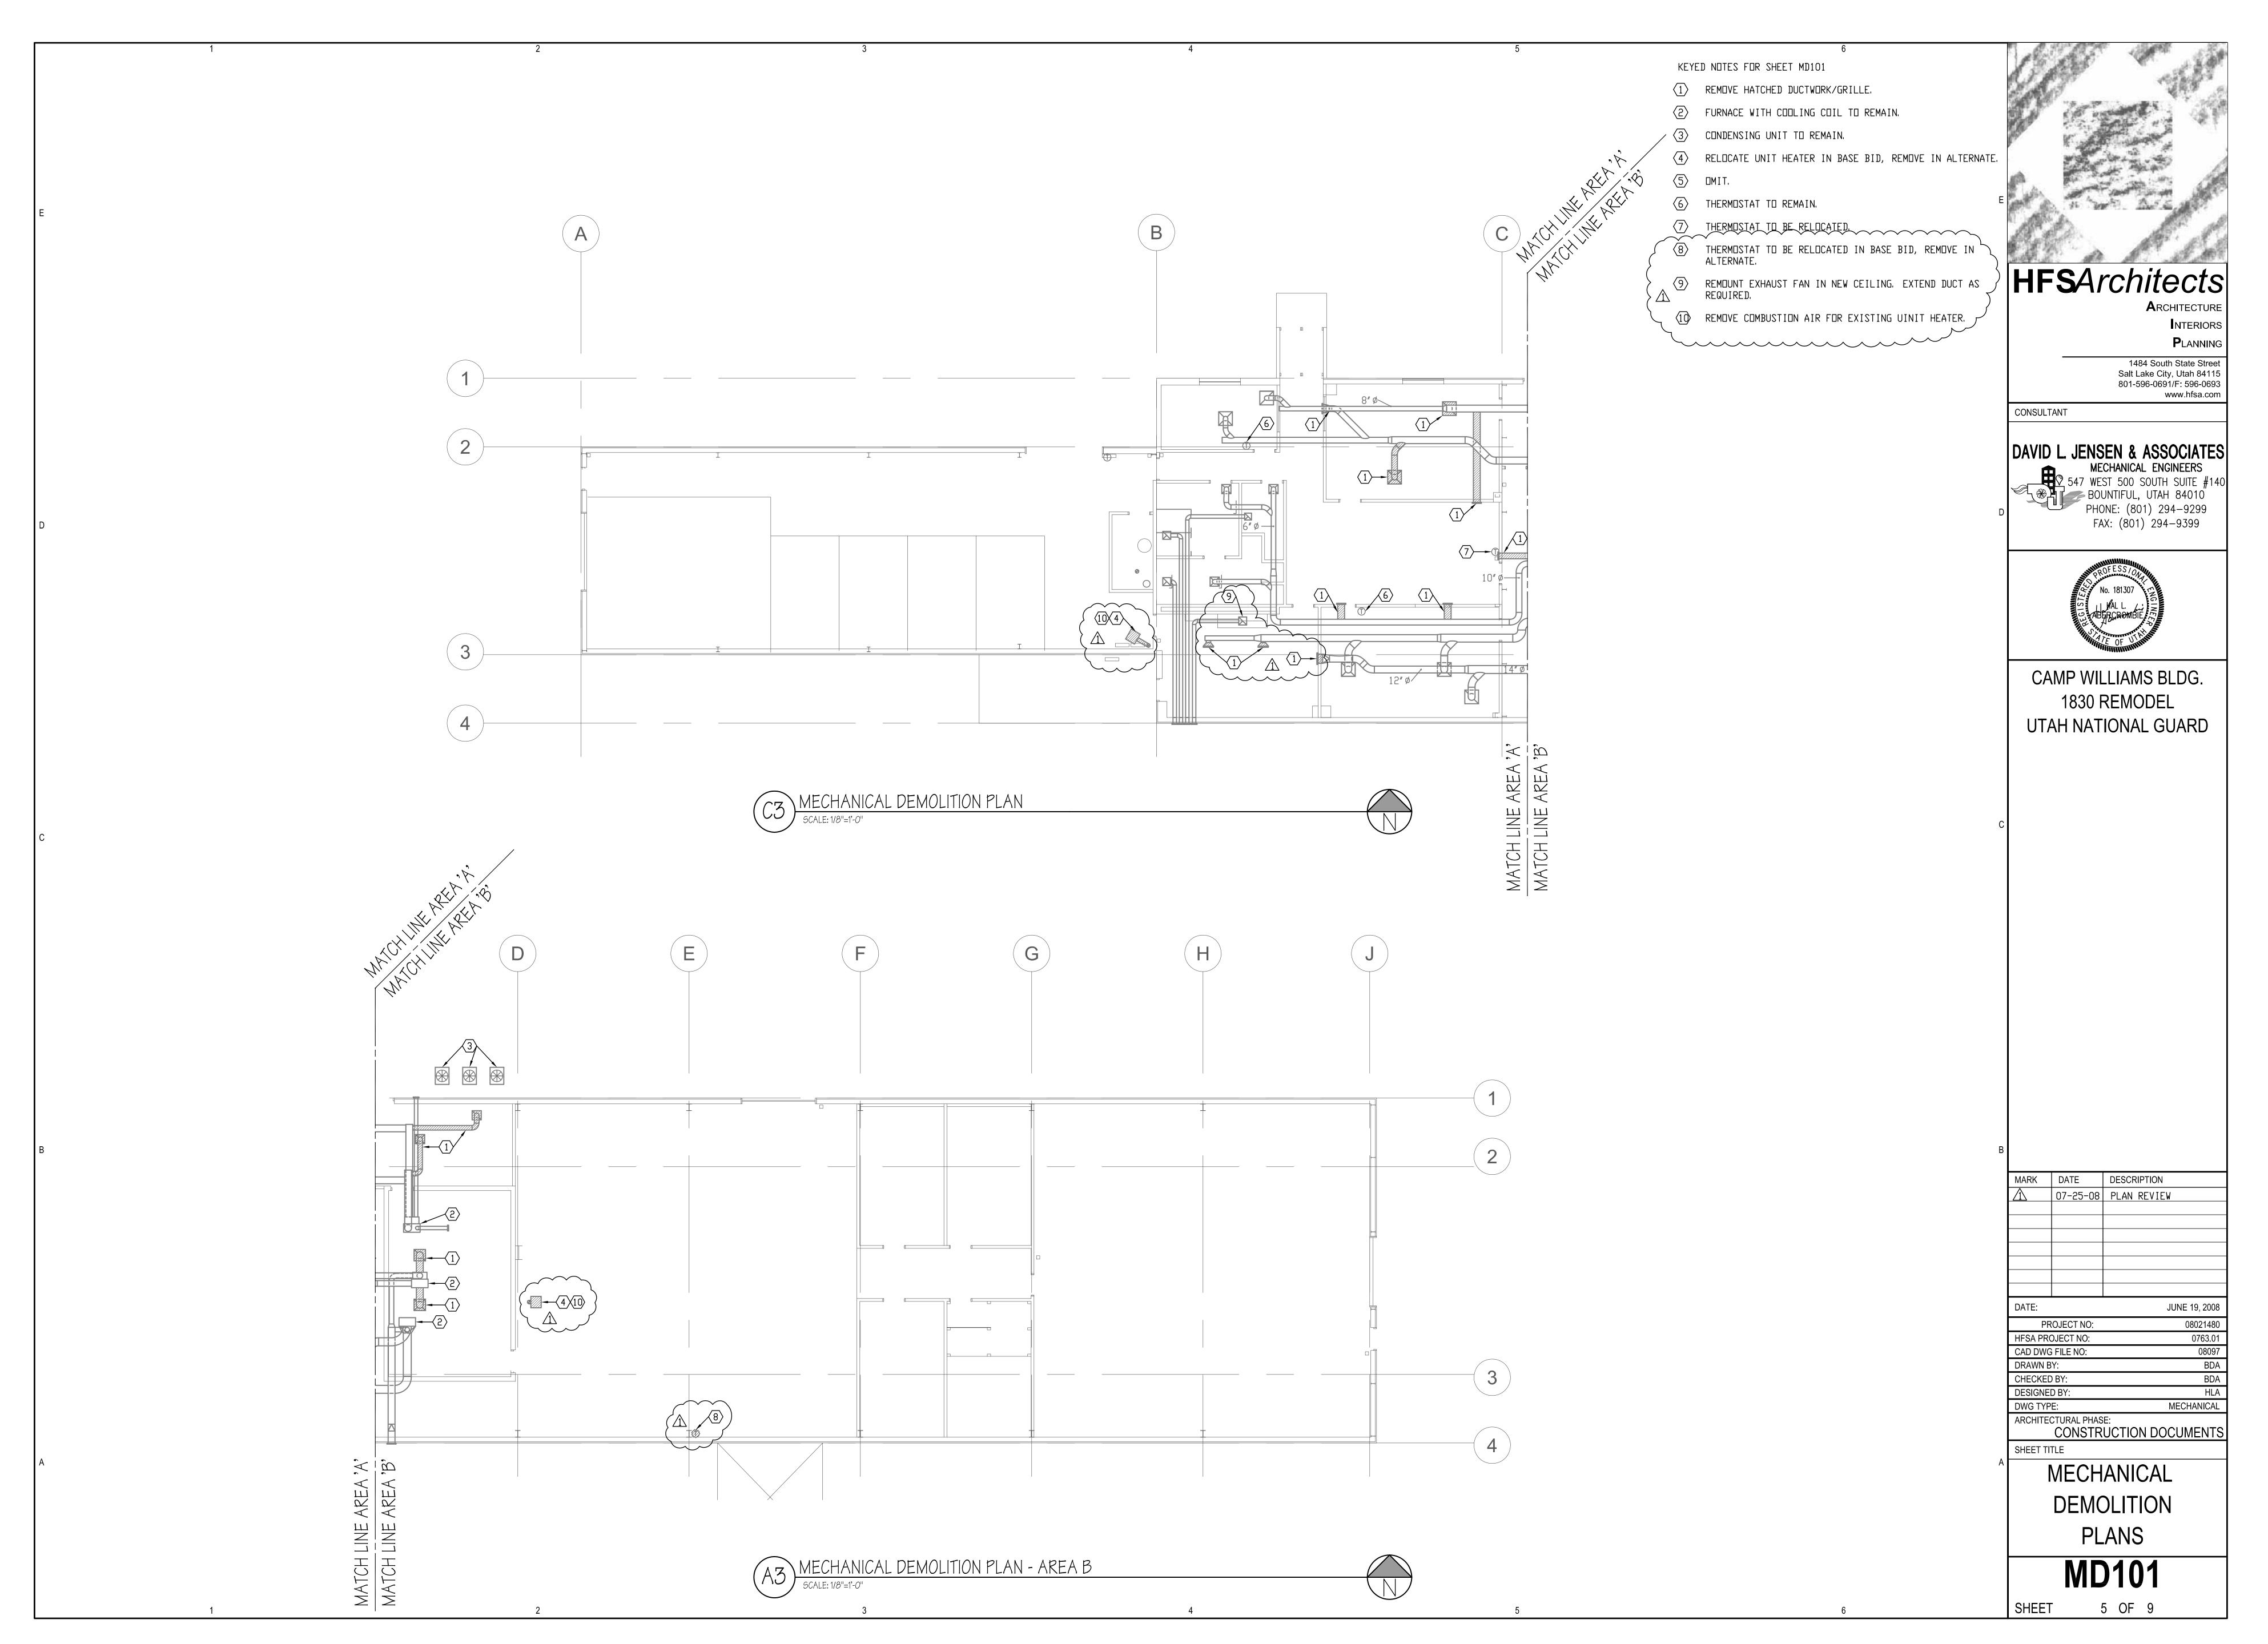

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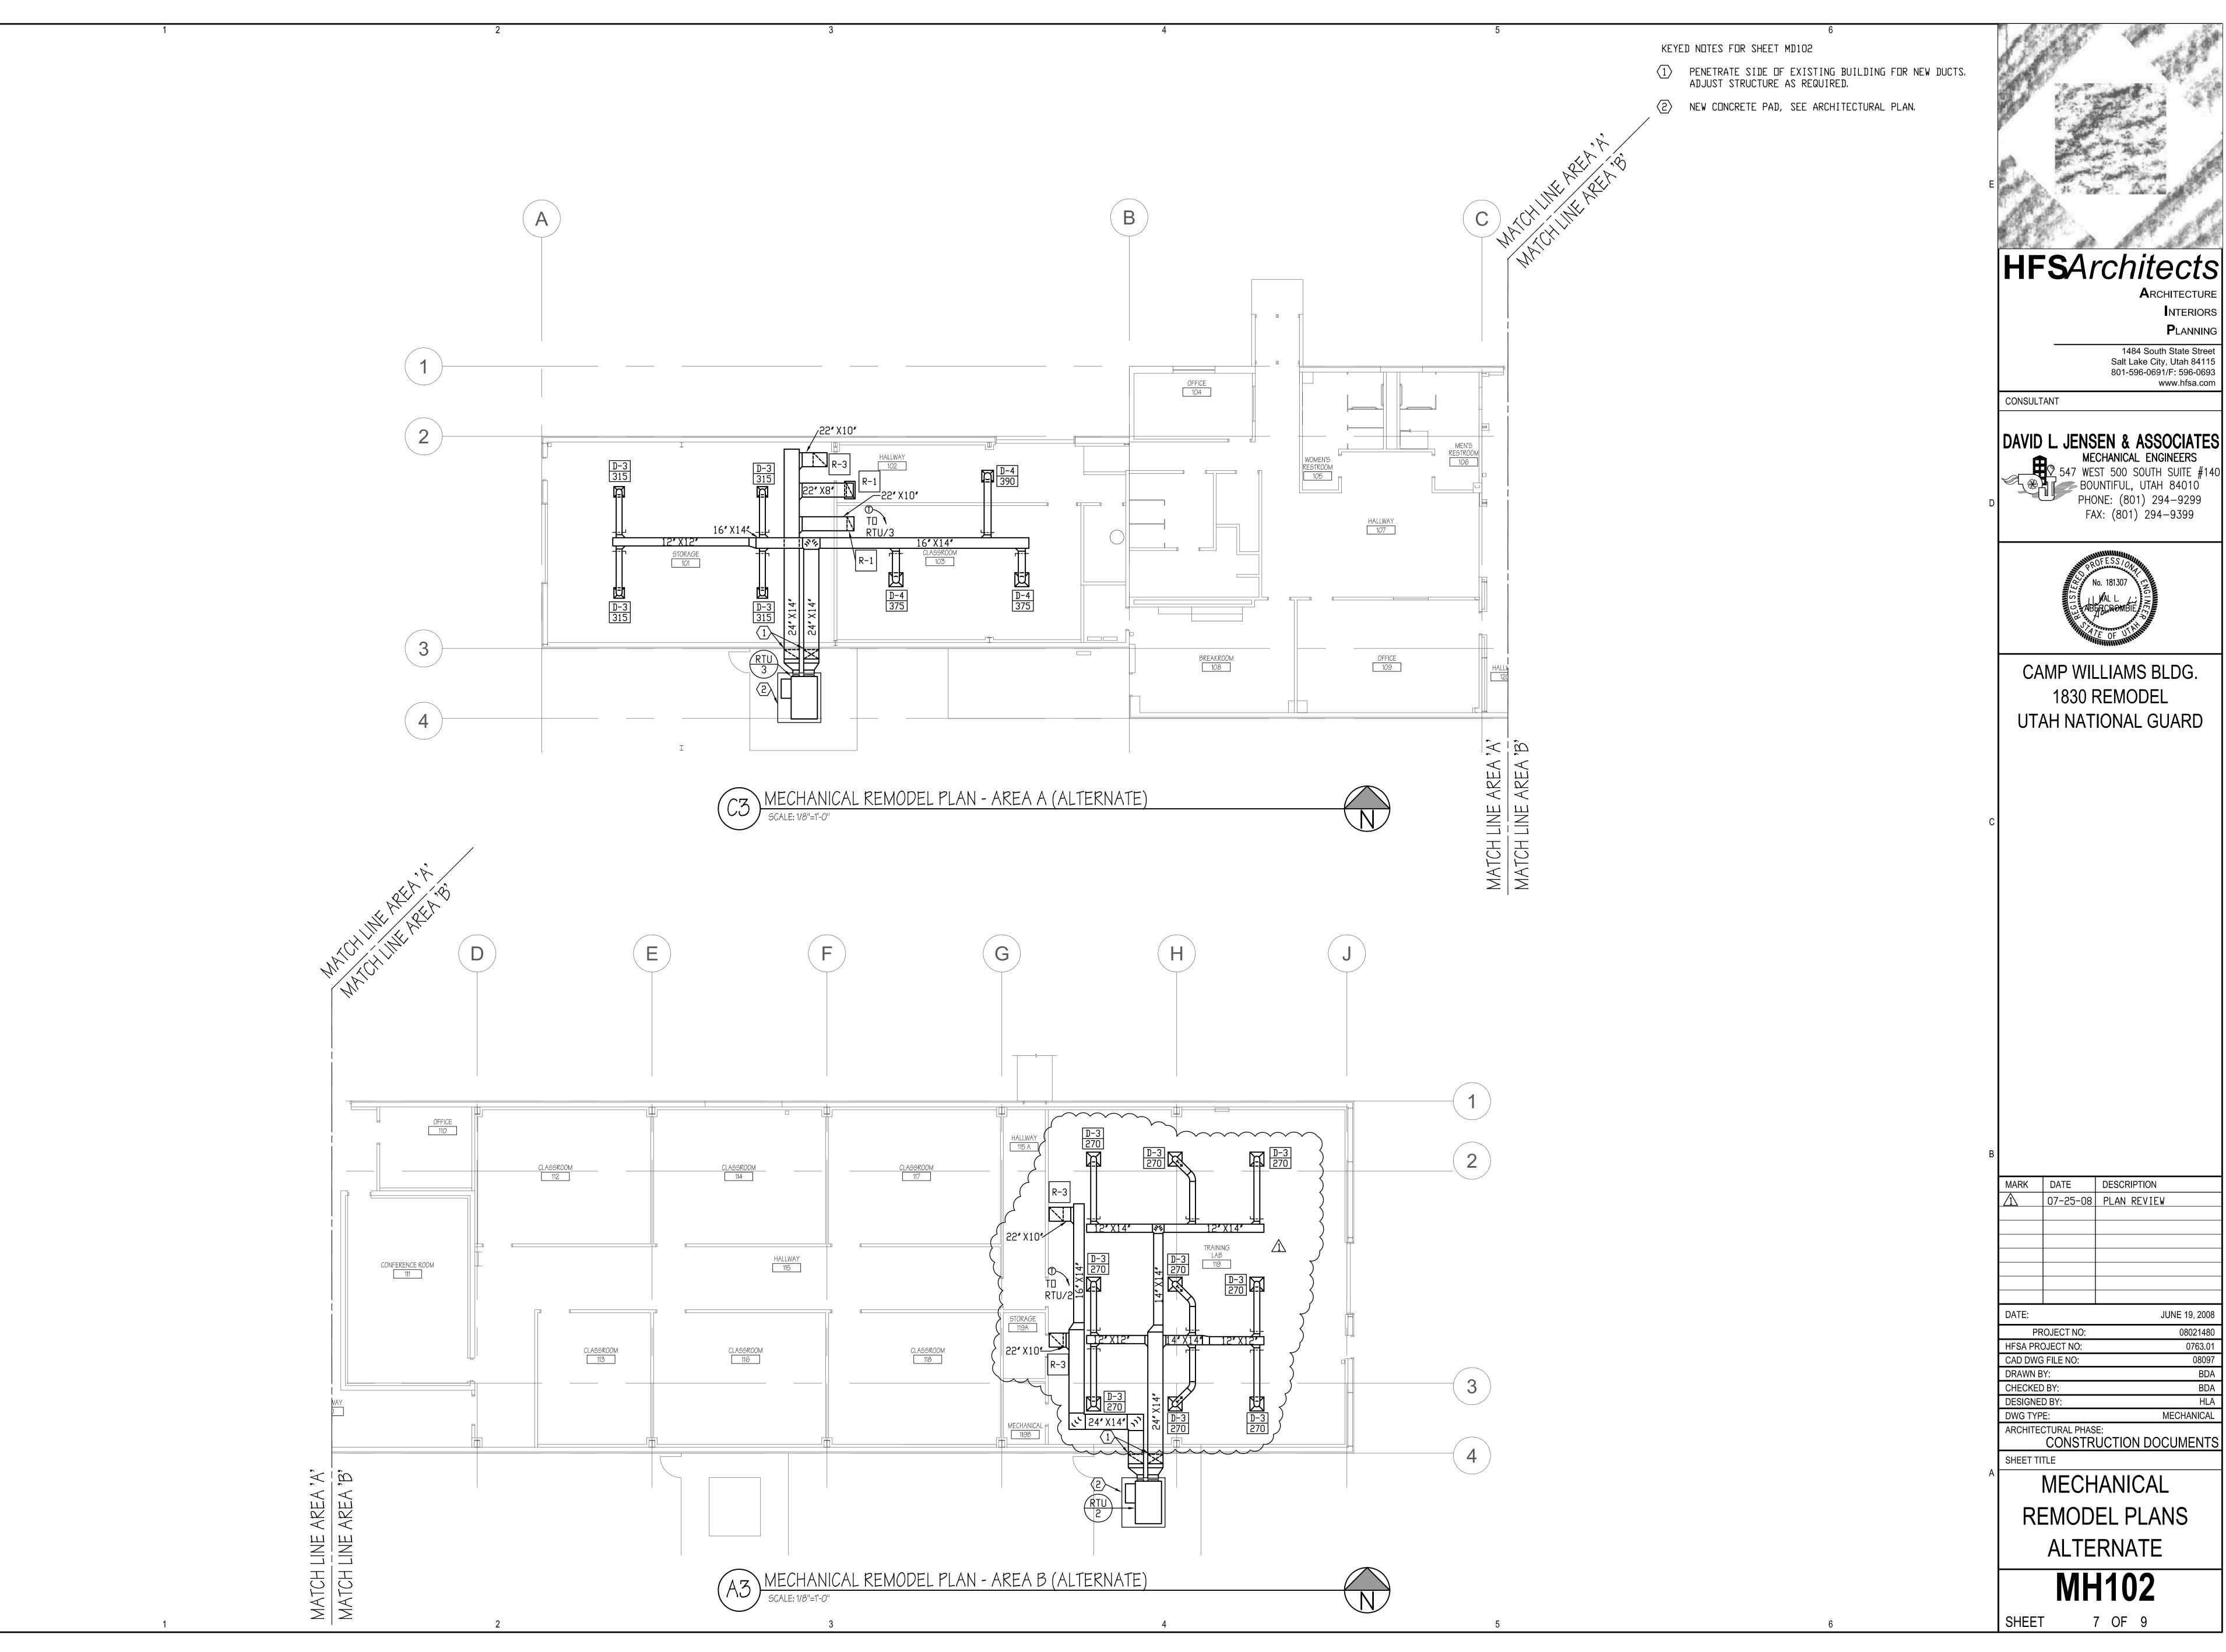
CAMP WILLIAMS BLDG. 1830 REMODEL UTAH NATIONAL GUARD

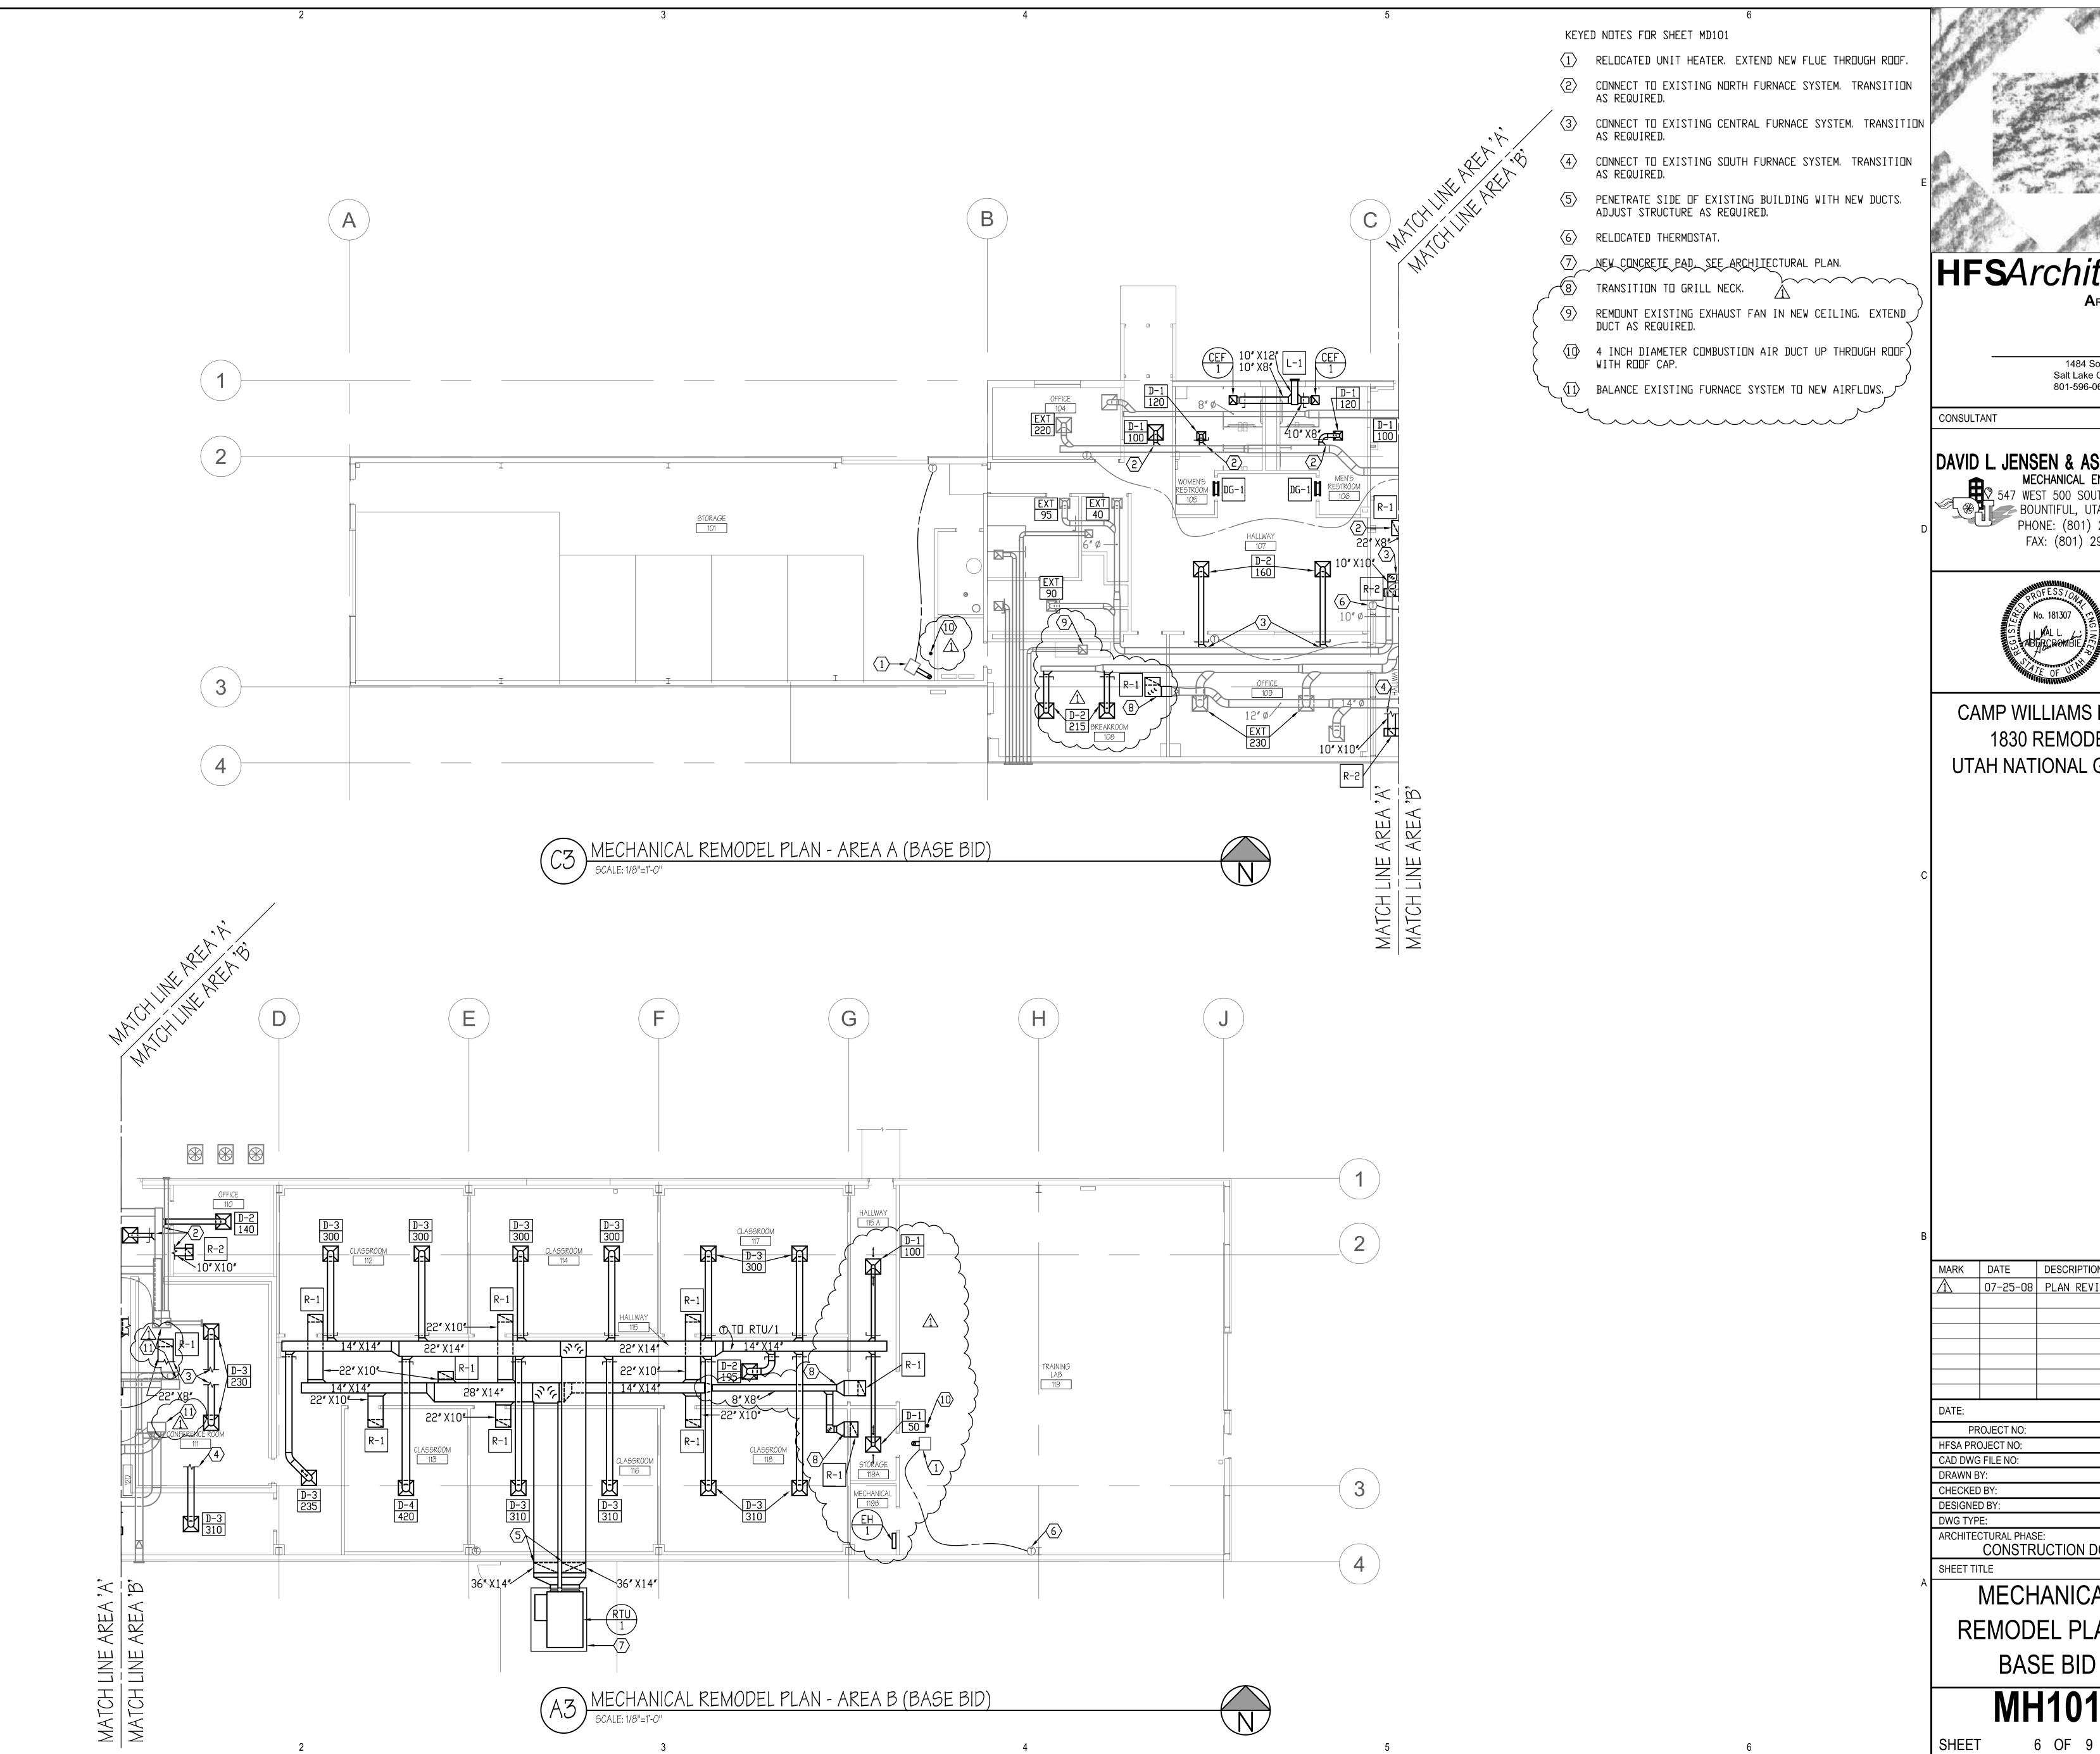DESCRIPTION 07-25-08 PLAN REVIEW

JUNE 19, 2008 PROJECT NO: HFSA PROJECT NO: MECHANICAL ARCHITECTURAL PHASE:
CONSTRUCTION DOCUMENTS

MECHANICAL REMODEL PLANS BASE BID

MH101




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0763.01 08097 BDA MECHANICAL

	H.V.A.C.	LEGEND
SYMBOL	ABBREVIATION	DESCRIPTION
		BRANCH DUCT TAKE-OFF
		DUCT FLEXIBLE CONNECTION
		TURNING VANES
		DUCT TEE CONNECTION
		DUCT TRANSITION
		SQUARE TO ROUND DUCT TRANSITION
		AUTOMATIC DAMPER
		OPPOSED BLADE VOLUME DAMPER W/CONCEALED CEILING DPR REGULATOR
		BACK-DRAFT DAMPER
<u> </u>		DUCT ACCESS DOOR
	RA	RETURN AIR, RISE AND DROP
	SA	SUPPLY AIR, RISE AND DROP
	EA	EXHAUST AIR, RISE AND DROP
	ΠA	OUTSIDE AIR, RISE AND DROP
	ATC	AUTOMATIC TEMP. CONTROL
[☐FD	FD	FIRE DAMPER
FSD	FSD	FIRE SMOKE DAMPER
①		THERMOSTAT
S		SENSOR
X-#		AIR DEVICE
X-# #		AIR DEVICE CFM
#		REFERENCE NOTE
(Z#) X		DETAIL NUMBER SHEET DETAIL APPEARS
X #		EQUIPMENT TYPE EQUIPMENT NUMBER

	HANGE	R SIZES FOR I	RECTANGULAR	DUCT
	MAX. SIDE	HANGER	HORIZONTAL SUPPORT ANGLE	MAXIMUM SPACING
	UP TD 34"	1"X18 GAUGE STRAP	NONE REQUIRED	8' -0"
	01 10 01	1 X10 GROGE STRIN	NEINE NEGOTNED	
(1) #10 X 2 @ EACH TRUS	″ WOOD SCRE	AS PER THE SULATION 5/8" GYPSUM BUARD HANGER STR 1" #10 X 3/4" CADMIUM PLASCREWS TO A DUCT. ALL STIGHT AGAIN	SELF-TAPPING— ATED SHEET METAL ANCHOR STRAPS TO STRAPS ARE TO BE NST DUCT AND MBERS. (TYP)	

4 DUCT STRAP HANGER DETAIL
SCALE NONE

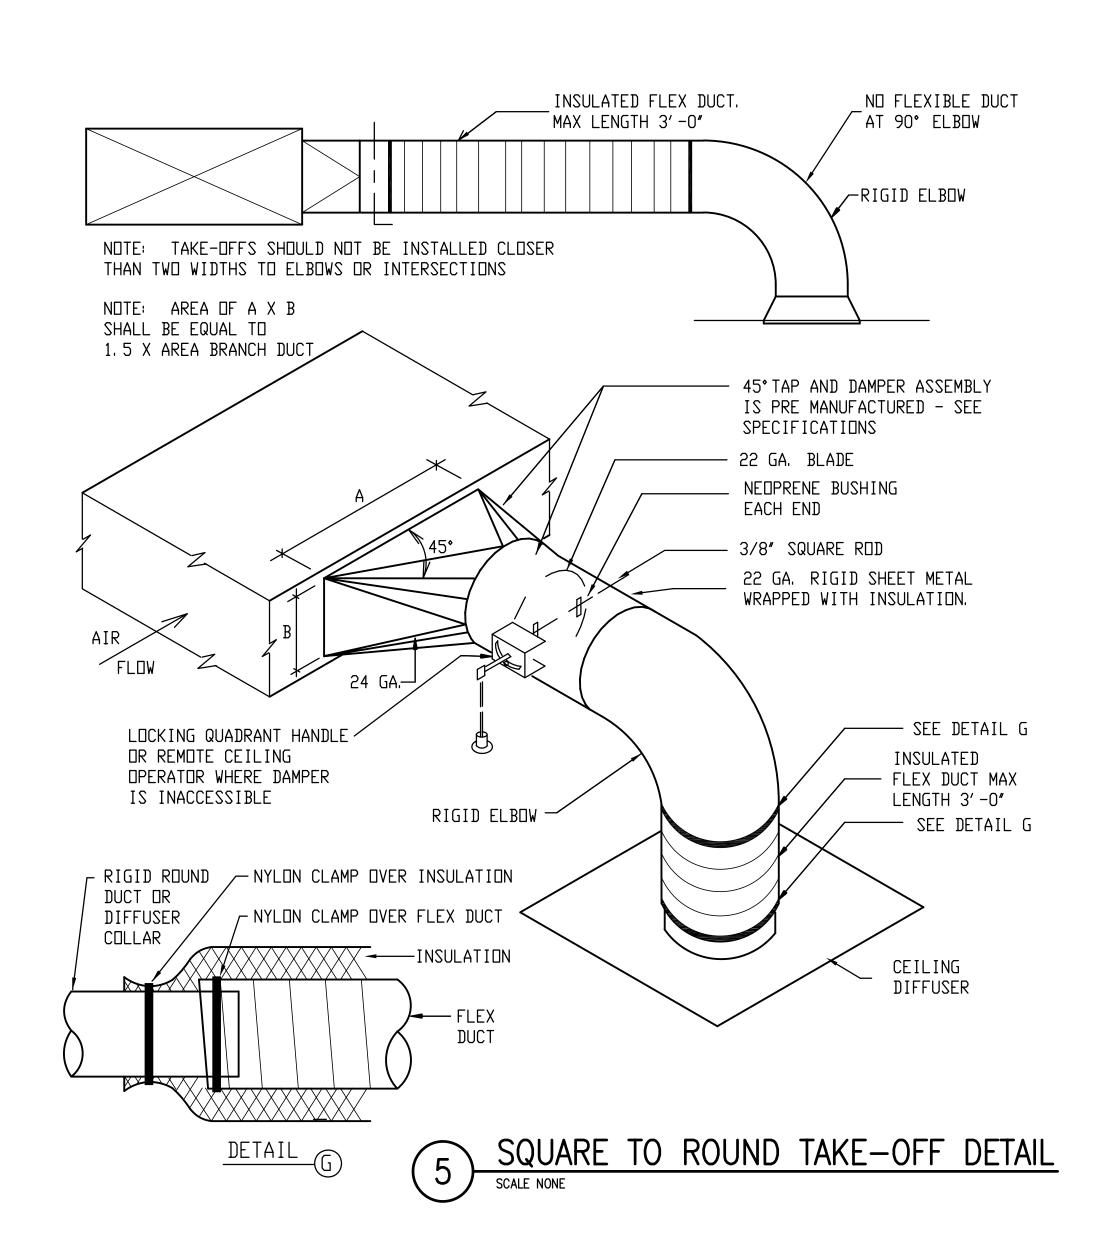


		TRANSVERSE	REIN	FORCING (1)		
DIMENSION OF LONGEST SIDE, INCHES	SHEET METAL GAUGE (ALL FOUR SIDES)	MINIMUM REINFORCING ANGLE SIZE & MAXIMUM LONGITUDINAL SPACING BETWEEN JOINTS &/OR INTERMEDIATE REINFORCING	MIN. H, IN.	AT JOINTS DRIVE SLIP PLAIN S SLIP RECOM- MENDED GAUGE	HEMMED S SLIP RECOM- MENDED GAUGE	ALTERNT. BAR SLIP RECOM- MENDED GAUGE	REINFOR. BAR SLIP RECOM- MENDED GAUGE
UP THRU 12	26	NONE REQ.	1	26	26	24	24
13 - 14	24	NDNE REQ.	1	24	24	24	24
15 - 18	55	NONE REQ.	1	55	55	22	22
19 - 20	20	NONE REQ.	1	20	20	20	20
21 - 26	18	NONE REQ.	1	18	18	18	18
27 - 30	16	NONE REQ.	1	16	16	16	16
31 - 36	20	1-1/4" X 1-1/4" X 18GA. @ 10'	1	-	-	20	20
37 - 42	18	1-1/2" X 1-1/2" X 16GA. @ 10'	1	-	-	18	18
43 - 48	16	1-1/2" X 1-1/2" X 1/8" @ 10'	1	-	_	16	16

① TRANSVERSE REINFORCING SIZE IS DETERMINED BY DIMENSION OF SIDE TO WHICH ANGLE IS APPLIED

②FOR OTHER GAUGE DUCT, SEE SMACNA.


DUCT CONSTRUCTION DETAIL

SCALE NONE

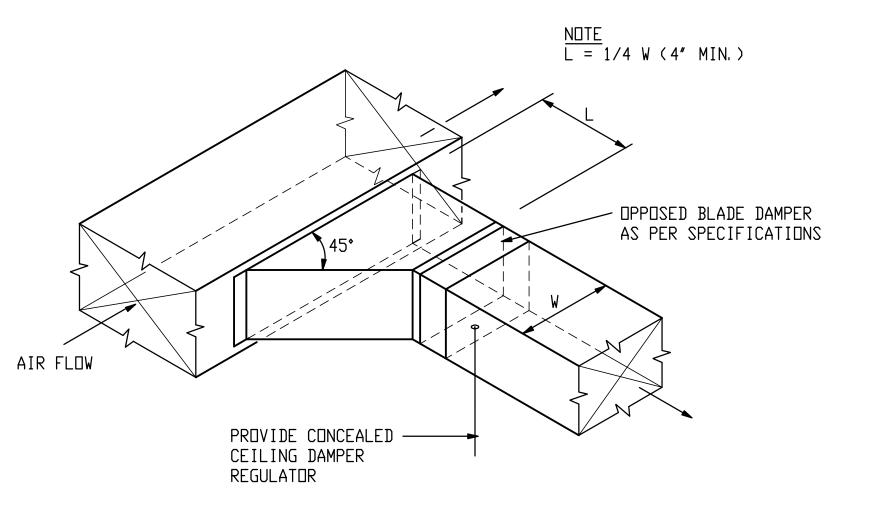


2 BRANCH DUCT TAKE-OFF & DAMPER DETAIL

SCALE NONE

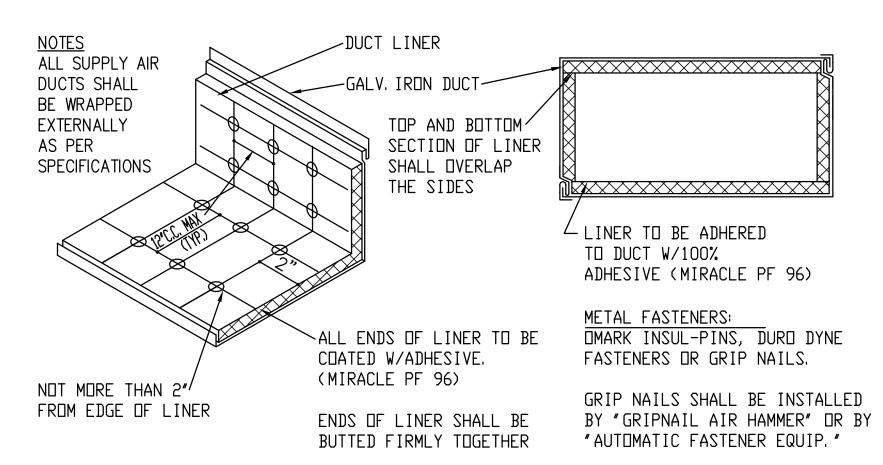

3 DUCT LINER DETAIL

SCALE NONE

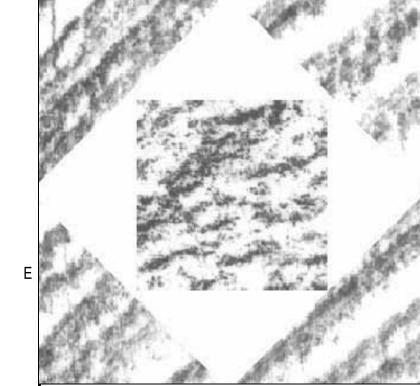

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MECHANICAL ENGINEERS

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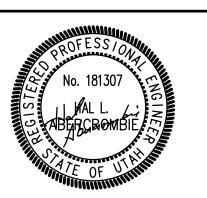
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CAMP WILLIAMS BLDG. 1830 REMODEL UTAH NATIONAL GUARD

MARK	DATE	DESCRIPTION

DATE:	JUNE 19, 2008
PROJECT NO:	08021480
HFSA PROJECT NO:	0763.01
CAD DWG FILE NO:	08097
DRAWN BY:	BDA
CHECKED BY:	BDA
DESIGNED BY:	HLA
DWG TYPE:	MECHANICAL
ARCHITECTURAL PHASE: CONSTRUCTION	DOCUMENTS

MECHANICAL DETAILS

& LEGEND M501

SHEET 8 OF 9

							ROOF	TOP P	ACKAGE	D UNIT SCHE	DULE	•				
MARK _	FAN AIRFLOW CFM	EXT STATIC	HEATING INPUT MBH	SL OUTPUT	EAT DEG F	COOLING MIN NOMINAL TONS	TDTAL MBH	SENSIBLE MBH	EAT DEG F DW/WB	ELECTRICAL REQUIREN VOLTS/HERTZ/PHASE		MDCP	WEIGHT LBS.	MIN. D.A. CFM	CARRIER MODEL	REMARKS
RTU 1	4, 000	0. 70	180	136	51	10	113	113	80/56	208/60/3	59. 0	70	1000	1200	48HJF012	
RTU 2	2, 430	0. 60	150. 0	120. 0	53. 8	6	74. 6	73. 7	77/60	208/60/3	38. 8	45	850	1000	48HJF007	
RTU 3	2, 400	0. 60	72	54	60	6	68. 5	64. 3	77/55	208/60/3	38. 8	45	850	420	48HJE	

REQUIRED OPTIONS:

THE FOLLOWING ITEMS ARE FACTORY INSTALLED ONLY:

DISCONNECT SWITCH ACCESSIBLE FROM OUTSIDE OF UNIT. COMES WITH SPRING LOADED WEATHERPROOF COVER, FINAL CONNECTION TO POWER PANEL BY ELECTRICAL CONTRACTOR.

(1) SERVICE DUTLET @ 115 VOLT WITH GROUND FAULT CIRCUIT INTERRUPTER GFCI TYPE, FINAL CONNECTION TO POWER PANEL BY ELECTRICAL CONTRACTOR.

TWO-STAGE HEAT.

THE FOLLOWING ITEMS ARE FACTORY OR FIELD INSTALLED:

④ ECONOMIZER WITH OPPOSING GEAR DRIVEN RECIRCULATED AIR AND OUTDOOR AIR DAMPERS. PROVIDE WITH NYLON BEARINGS AND NEOPRENE SEALS. FULLY MOUNTED SPRING

RETURN MOTOR WITH ADJUSTABLE MINIMUM DAMPER POSITION. OUTDOOR AIR HOOD SHALL BE REQUIRED WITH ECONOMIZER. THREE CLEANABLE ALUMINUM MESH FILTERS FURNISHED.

DUTDOOR ENTHALPY CONTROL WITH ADJUSTABLE ENTHAPLY SENSOR, MODULATES FROM 0 TO 100% DUTSIDE AIR. SMOKE DETECTOR - PHOTOELECTRIC TYPE. INSTALLED IN THE RETURN AIR SECTIONS OF UNITS OVER 2000 CFM.

THE FOLLOWING ITEMS ARE FIELD INSTALLED ONLY:

ROOF MOUNTING FRAME FURNISHED WITH NAILER STRIP. 14" TOTAL FRAME HEIGHT.

INSTALLING CONTRACTOR SHALL INSTALL NAMEPLATES PERMANENTLY ATTACHED TO THE R. T. U. NAMEPLATES SHALL BE ENGRAVED LAMINATED PLASTIC OR ETCHED RUSH PROOF METAL.

UNIT SHALL ATTAIN COOLING CAPACITY AT 95 DEG F. OUTSIDE AIR.

PROVIDE WITH POWER EXHAUST FAN TO ACHIEVE 100% RELIEF.

	ELEC	TRIC W	'ALL	HEAT	ER S	CHE	DULE
MARK	SERVES	K. W. Output	ELE ø	CTRICAL HERTZ	VOLTS	AMPS	REMARKS
EH 1	FIRE RISER ROOM	3	1	60	208	14. 4	COMPLETE WITH THERMOSTAT CONTROL

1. THE MECHANICAL CONTRACTOR SHALL VERIFY MOTOR VOLTAGES WITH THE ELECTRICAL \triangle DRAWINGS BEFORE ORDERING MOTORIZED EQUIPMENT AND CONTROLS. MOTOR NAME PLATE VOLTAGE SHALL BE NEMA STANDARD 200 VOLT FOR 208 VOLT THREE PHASE SYSTEM AND SHALL BE NEMA STANDARD 230 VOLT FOR 240 VOLT THREE PHASE OR SINGLE PHASE SYSTEM. STARTER HEATERS INSTALLED SHALL BE COORDINATED WITH THE NAME PLATE DATA. 2. S.C.F.M. LISTED IS STANDARD AIR.

	REGISTER,	LOUVER	R AND GRIL	LE SCH	EDULE
MARK	TYPE	SERVICE	CFM RANGE ①	NECK SIZE	REMARKS ②
R-1	CEILING	RA	0-800 🛕	22 X 10	
R-2	CEILING	RA	0-325	10 X 10	
DG-1	DOOR GRILLE	TA	215	18 X 12	
R-3	CEILING	RA	800-1500	22 X 22	
L-1	LOUVER	EA	450	16 X 12	

REGISTER AND LOUVER SCHEDULE NOTES:

MAXIMUM NC=25 @ MAXIMUM CFM N□TED. SEE SPECIFICATIONS FOR APPROVED MANUFACTURERS.

CEI	LING EX	HAUST	FAN SC	CHEDULE @
MARK	MIN ① S. C. F. M.	STATIC PRESSURE IN W. G.	WATTS ③	REMARKS
CEF 1	225	0. 4	130	①

① CONTROL BY DIV. 15. INTERLOCK WITH THERMOSTAT TO BE ON IN THE OCCUPIED MODE.

② PROVIDE BACK-DRAFT DAMPER. ③ VOLTAGE IS 115V/1 PHASE/60 HZ.

DI	FFUSER SCHI	EDULE @ 3
MARK	C. F. M. RANGE ①	NECK CONN.
D-1	0-120	6" DIA.
D-2	125-215	8" DIA.
D-3	230-330	10" DIA.
D-4	305-500	12" DIA.

DIFFUSER SCHEDULE NOTES:

(1) MAXIMUM NC=25 @ MAXIMUM CFM N□TED. ② SHALL BE TITUS TDC OR EQUAL BY OTHER APPROVED MANUFACTURERS (SEE

SPECIFICATION). 3 FINISH SHALL BE OFF-WHITE BAKED ENAMEL.

ARCHITECTURE


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MARK DATE DESCRIPTION 07-25-08 PLAN REVIEW

DATE: JUNE 19, 2008 08021480 PROJECT NO: 0763.01 HFSA PROJECT NO: 08097 CAD DWG FILE NO: DRAWN BY: CHECKED BY: BDA DESIGNED BY: DWG TYPE: MECHANICAL


ARCHITECTURAL PHASE:
CONSTRUCTION DOCUMENTS SHEET TITLE


> **MECHANICAL** SCHEDULES

> > M601

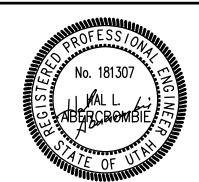SHEET

9 OF 9

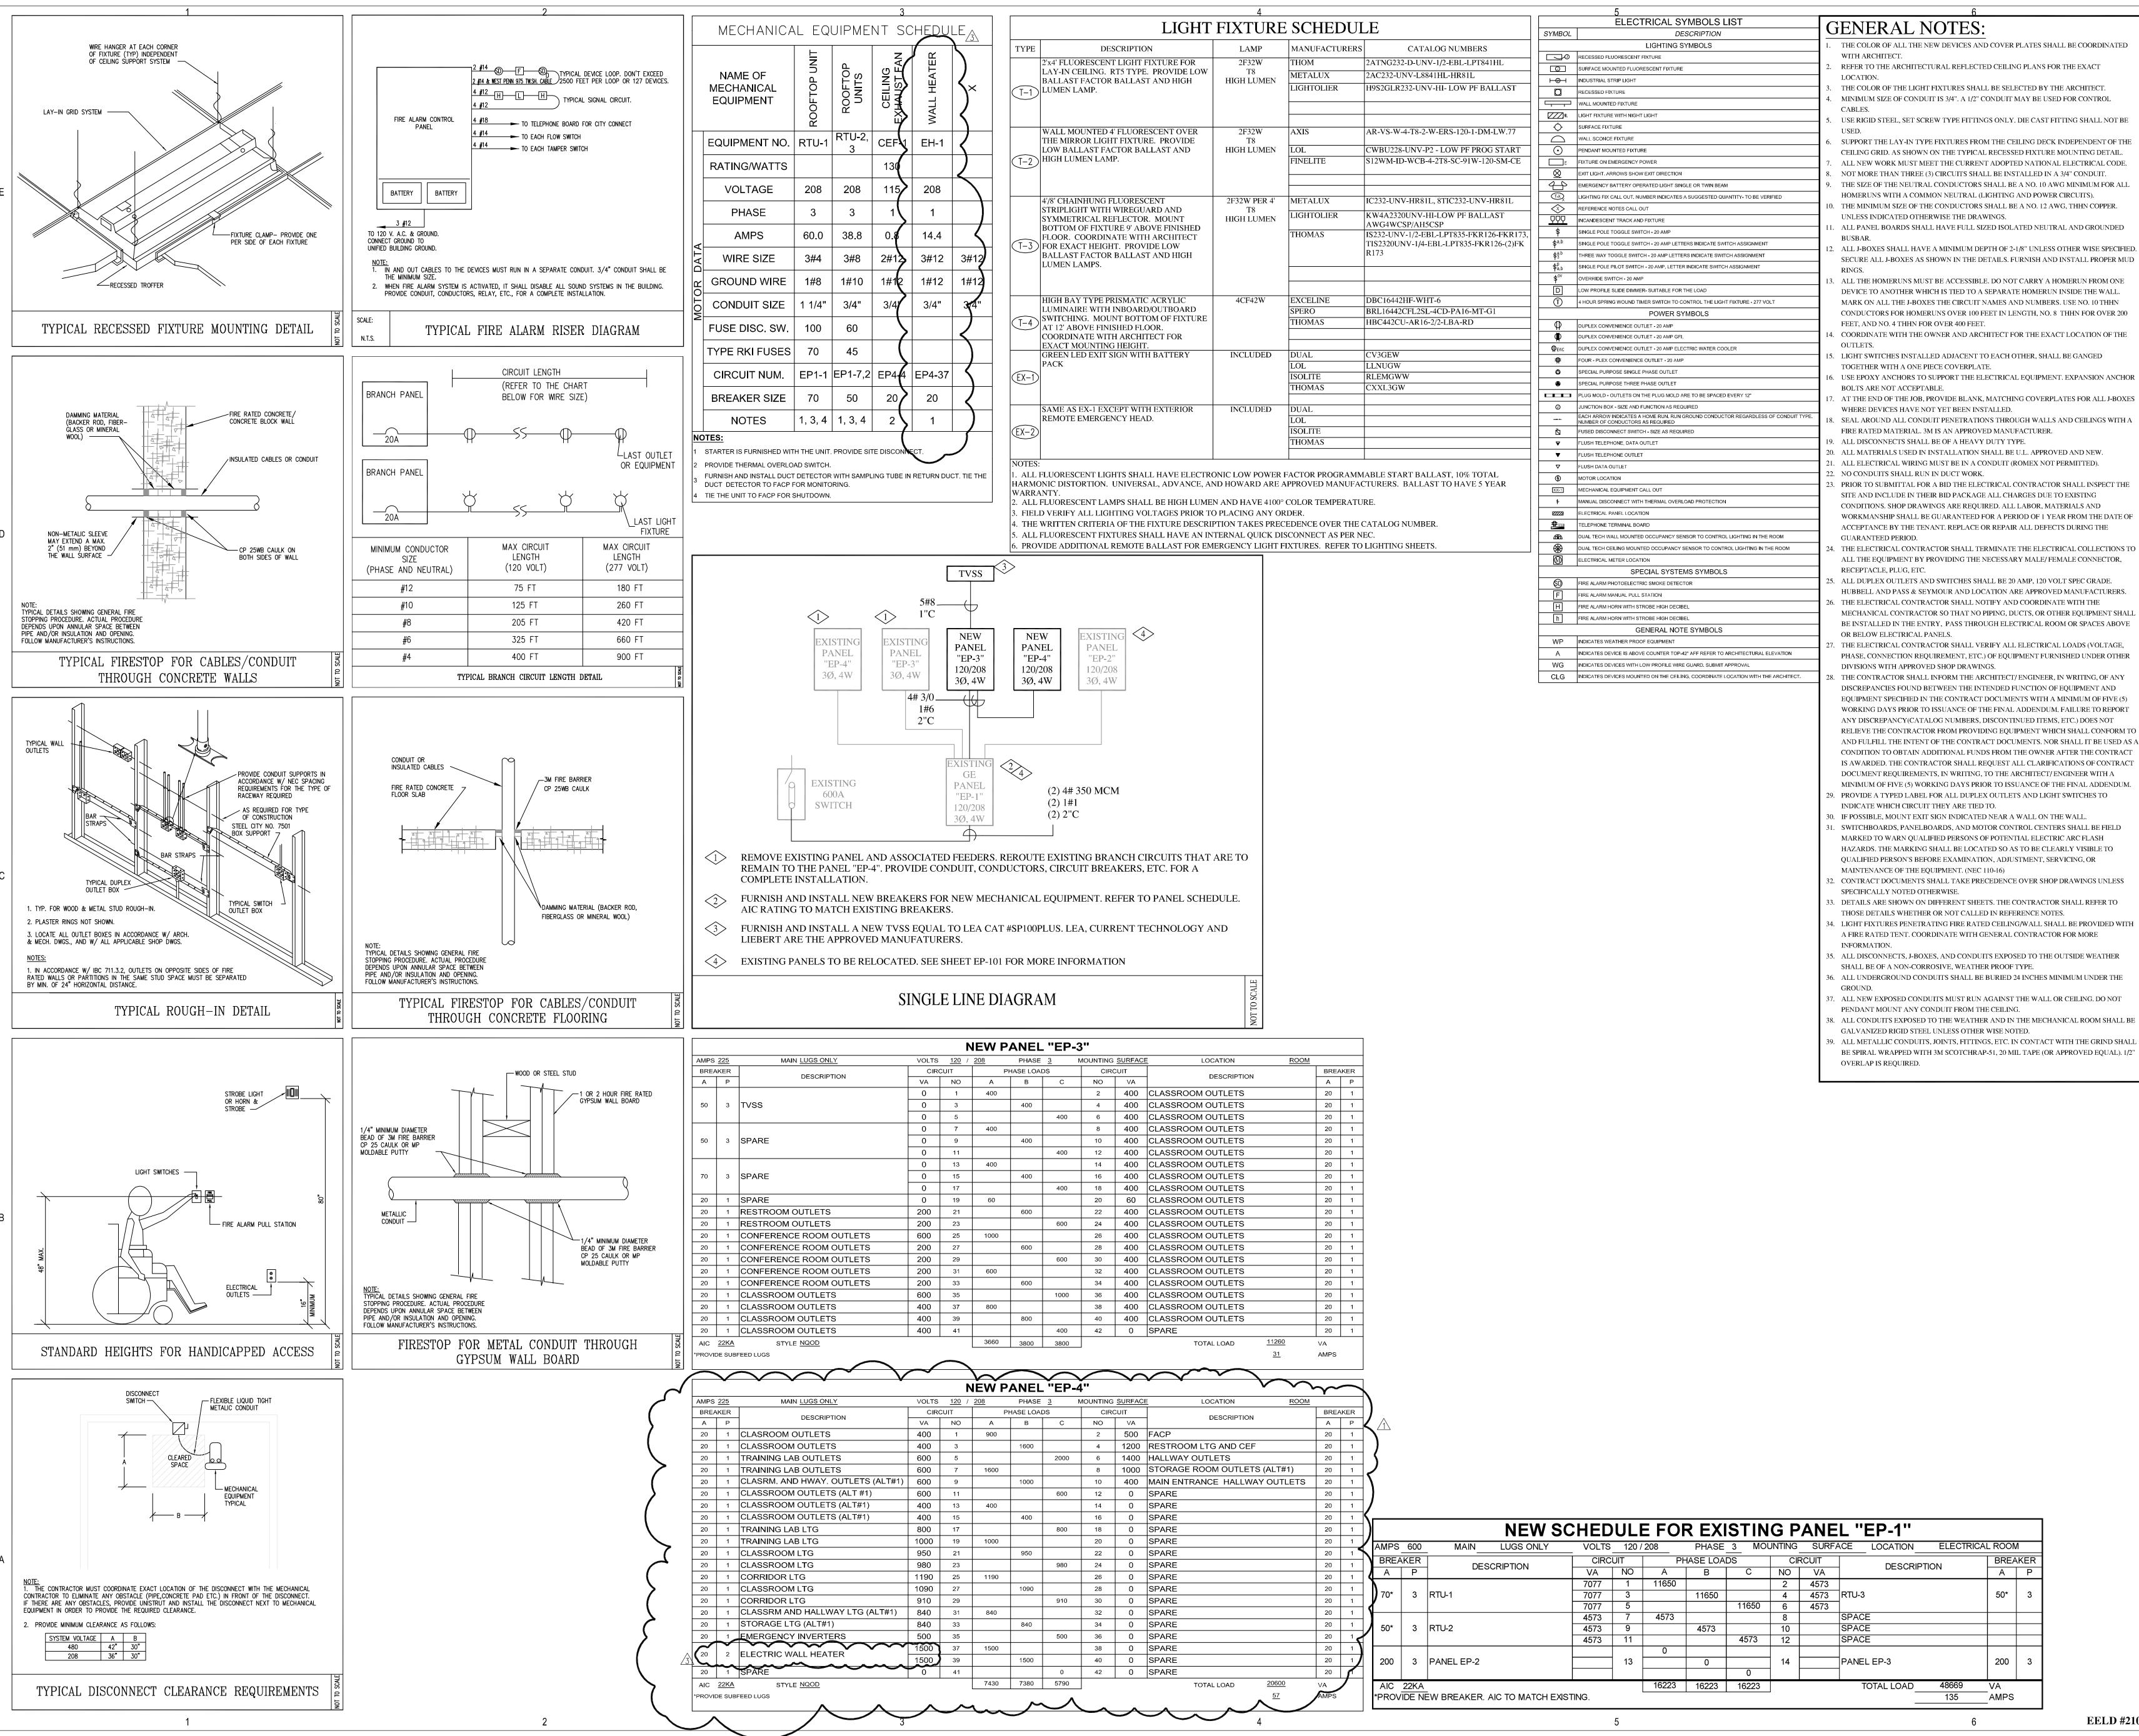

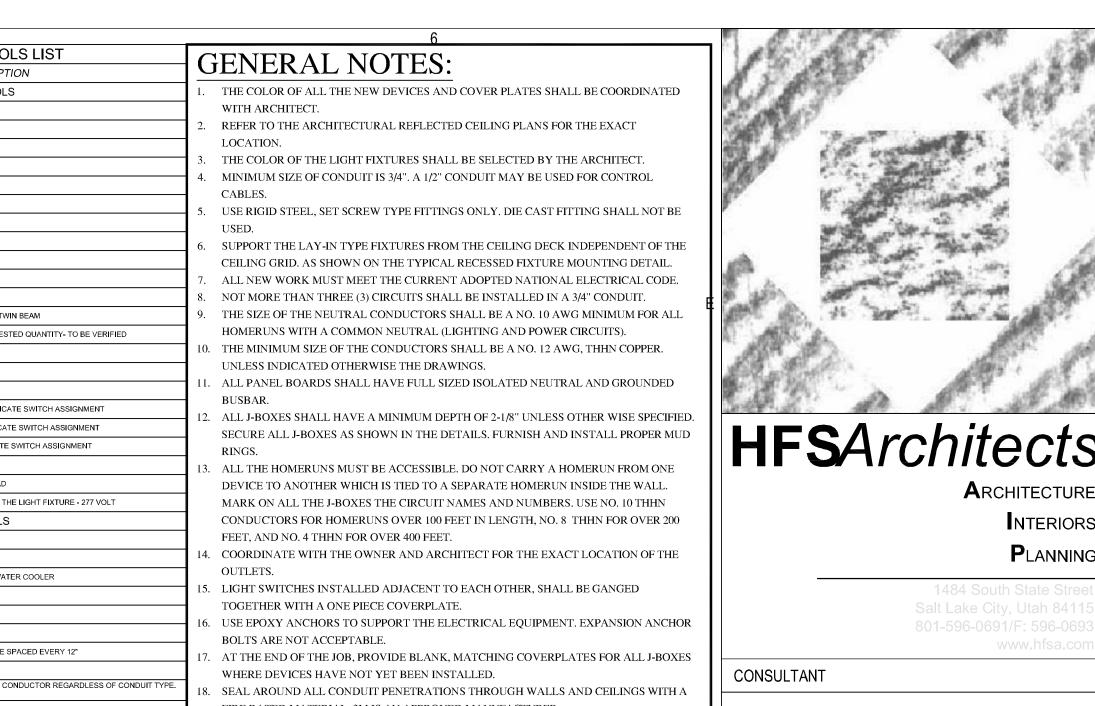





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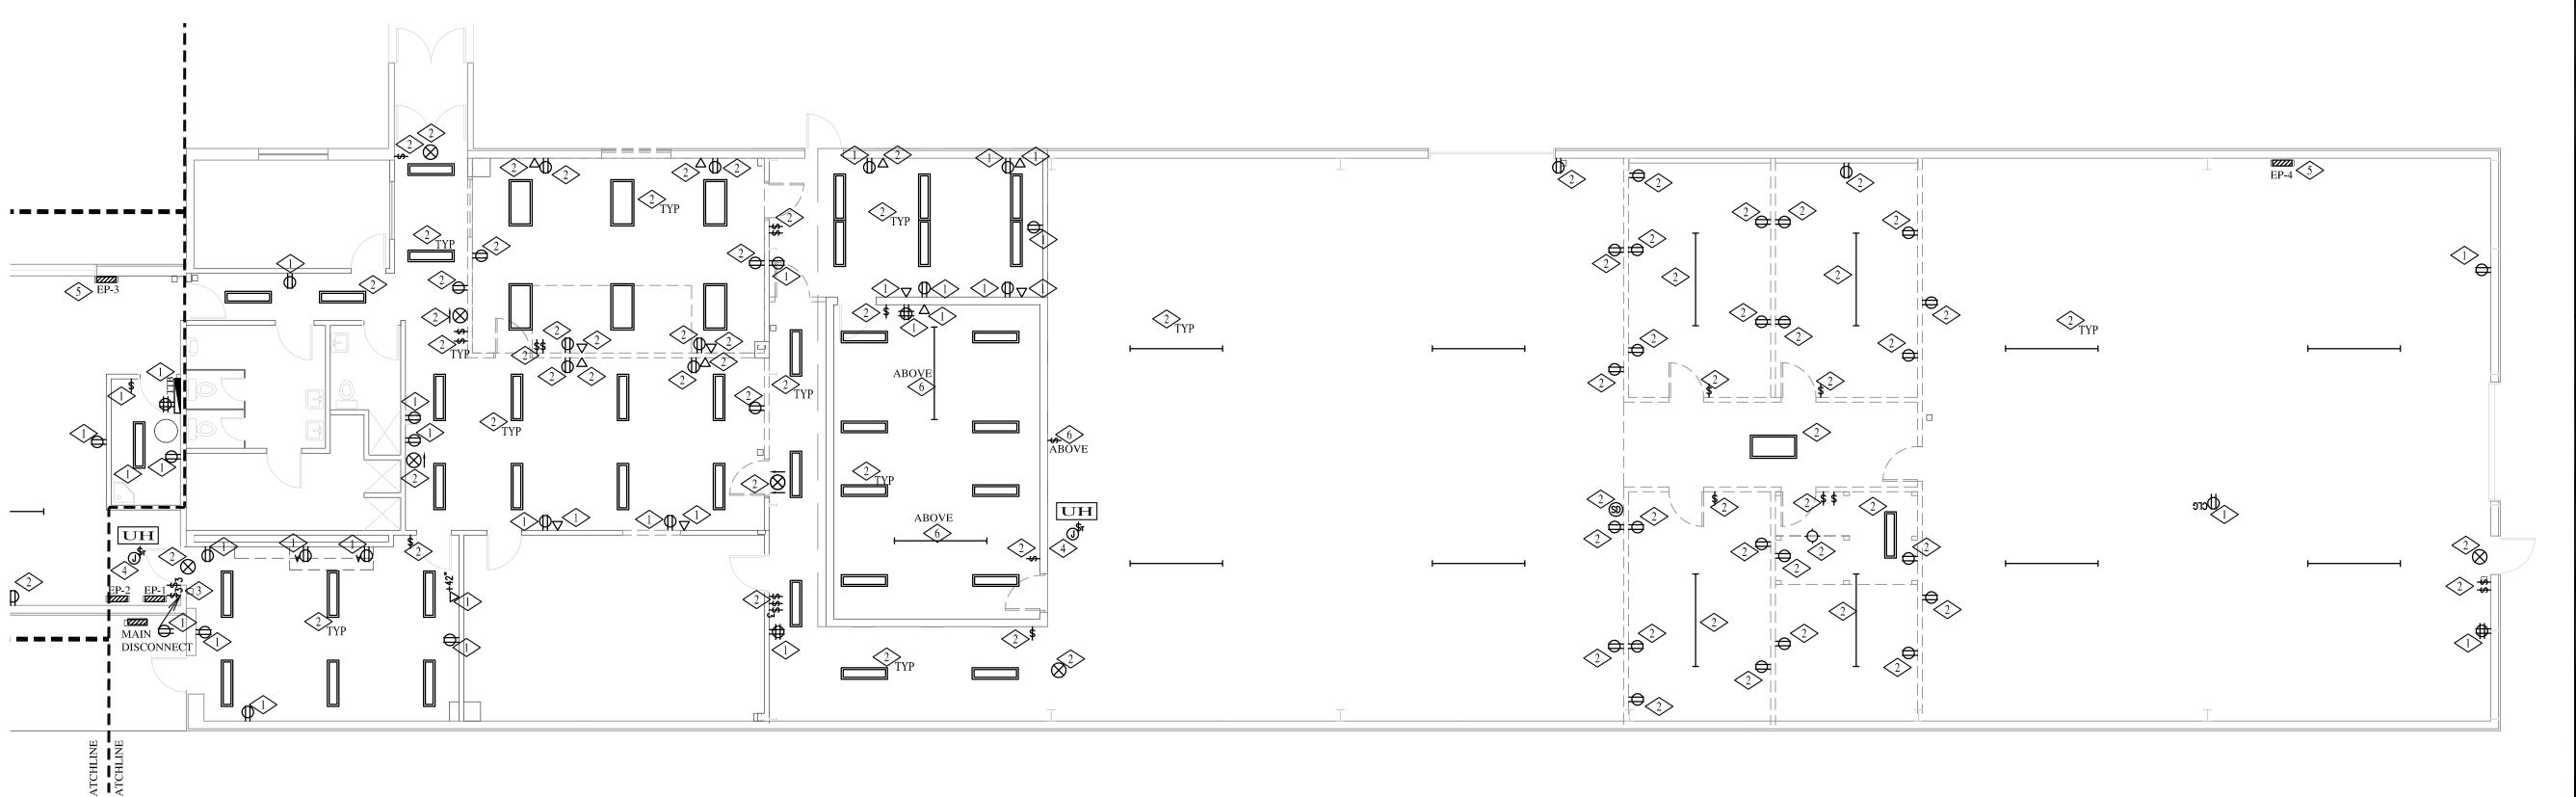
MARK	DATE	DESCRIPTION
\triangle	7/21/08	PLAN REVIEW
<u> </u>	8/11/08	PLAN REVIEW
3	8/11/08	MECH. UPDATE

DATE:		06-30-2008
PF	ROJECT NO:	
HFSA PR	OJECT NO:	0763.01
CAD DWG	FILE NO:	
DRAWN E	SY:	
CHECKE	BY:	
DESIGNE	D BY:	
DWG TYP	E:	
ARCHITE	CTURAL PHAS	SE:


SHEET TITLE

GENERAL NOTES, SCHEDULES, DETAILS, & DIAGRAMS

1 of 4 EELD #210 SHEET



KEYPLAN

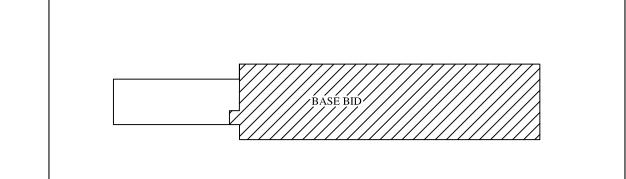

REFERENCE NOTES:

(1) EXISTING DEVICES TO REMAIN.

 $\langle 2 \rangle$ EXISTING DEVICES TO BE REMOVED.


- (3) EXISTING LIGHT SWITCHES TO BE RELOCATED. REFER TO SHEET EL-101 FOR NEW LOCATION.
- COORDINATE DEMOLITION OF ELECTRICAL CONNECTION TO MECHANICAL EQUIPMENT WITH THE MECHANICAL CONTRACTOR. REFER TO MECHANICAL DRAWINGS FOR MORE INFORMATION.
- EXISTING PANEL TO BE REMOVED. REROUTE ALL EXISTING REMAINING CIRCUITS TO PANEL "EP-4." PROVIDE CONDUIT, CONDUCTORS, RELAYS, ETC. FOR A COMPLETE INSTALLATION. THIS WORK TO BE PART OF BASE BID.
- (6) INSTALL NEW SWITCH TO CONTROL EXISTING LIGHTING IN MEZZANINE ABOVE ROOM. LOCATE SWITCH NEAR MEZZANINE ACCESS LADDER IN SOFFIT. COORDINATE EXACT LOCATION OF SWITCH WITH OWNER/ARCHITECT. PROVIDE CONDUIT, CONDUCTORS, ETC. FOR A COMPLETE INSTALLATION.

DEMOLITION NOTES:

- 1. IN THE EXISTING SPACE TO BE RENOVATED, THE CONTRACTOR SHALL REMOVE ALL LIGHT FIXTURES, SWITCHES, WIRING, WIRING DEVICES, CONDUITS, FIRE ALARM DEVICES, SPEAKERS, VOLUME CONTROLS, ETC. AS REQUIRED WHETHER OR NOT SHOWN ON THE DRAWINGS. COORDINATE WITH THE GENERAL CONTRACTOR PRIOR TO ANY DEMOLITION WORK AND REINSTALL DEVICES ON THE NEW CEILING IF NECESSARY.
- 2. ALL MATERIALS THAT ARE TO BE REMOVED FROM THE PREMISES SHALL BE RETURNED TO THE OWNER. MATERIALS WHICH THE OWN DECIDES NOT TO KEEP SHALL BE SALVAGED AND REMOVED FROM THE SITE BY THE CONTRACTOR.
- 3. ALL CONCEALED CONDUITS THAT CANNOT BE REMOVED SHALL BE CUT FLUSH WITH THE FINISHED SURFACES AND CAPPED OFF AFTER THE WIRING HAS BEEN DISCONNECTED AT THE PANEL AND REMOVED FROM THE CONDUIT.
- 4. IN AREAS WHERE CIRCUIT CONTINUITY IS INTERRUPTED, BUT MUST BE MAINTAINED BECAUSE OF THE NATURE OF THE FACILITY, MAKE ALL THE NECESSARY MODIFICATIONS TO THE CIRCUITS IN ORDER TO MAINTAIN THE CIRCUIT'S INTEGRITY.
- 5. DISCONNECT AND REMOVE EXISTING VOICE/DATA CABLING IN THE AREA BEING RENOVATED. COORDINATE THIS WORK WITH OWNER PRIOR TO REMOVAL.

SPECIAL NOTES:

1) REFER TO ARCHITECTURAL DRAWINGS FOR BASE BID AND ALTERNATE BID.

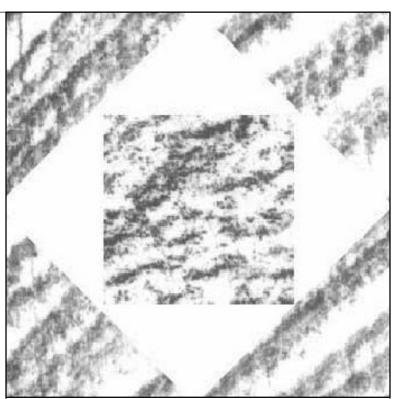

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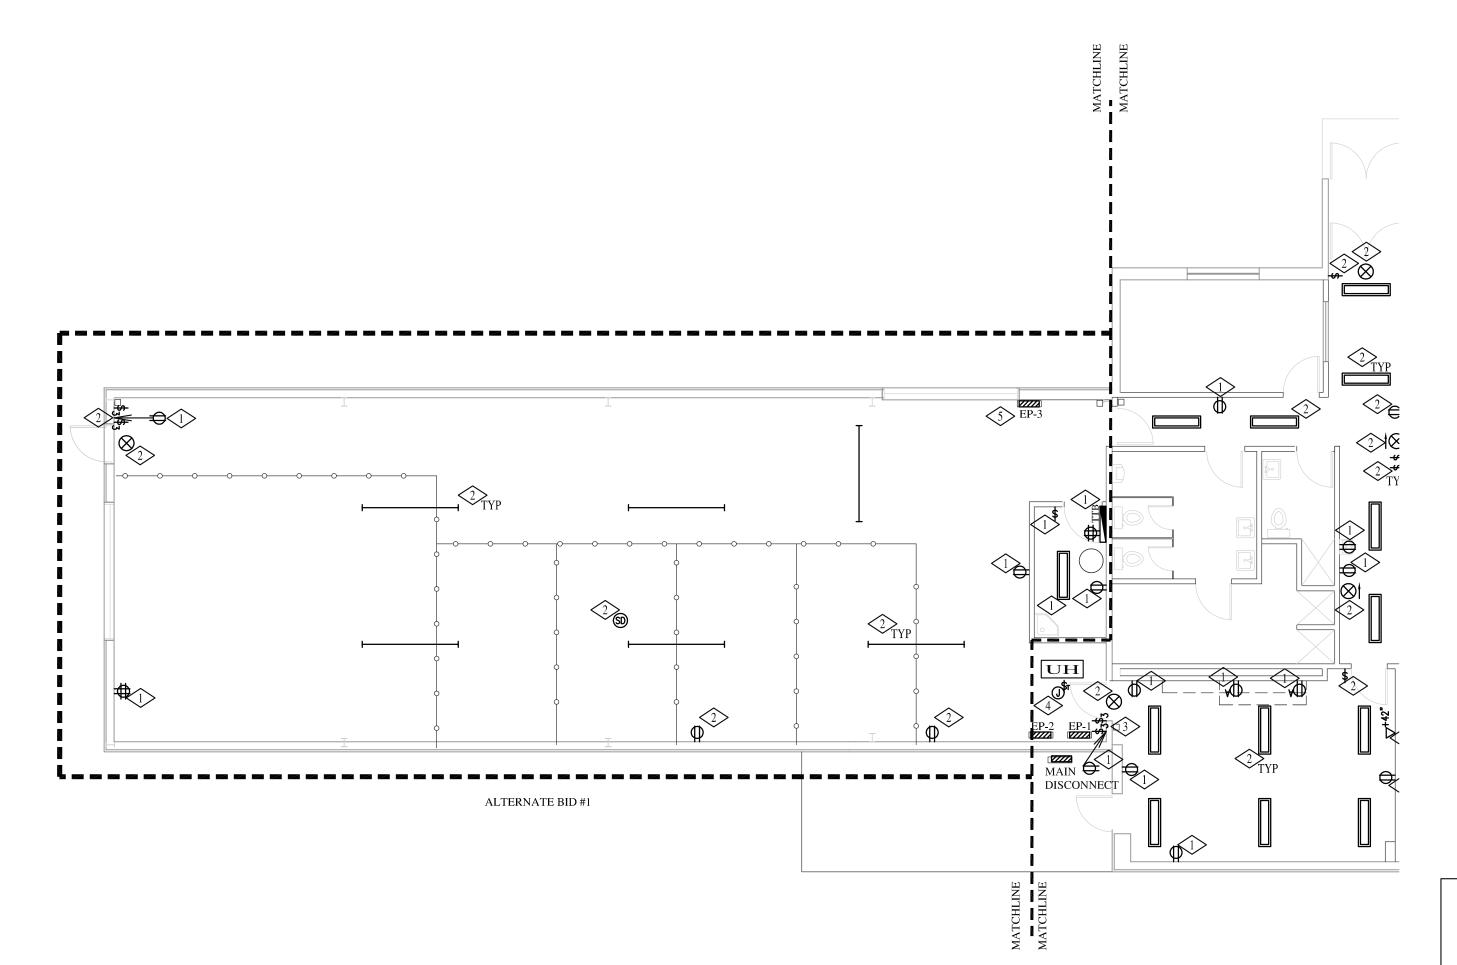
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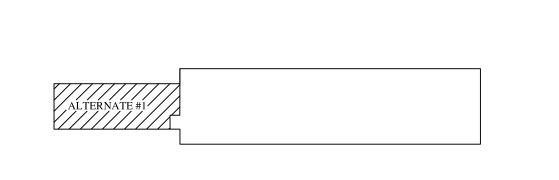


BASE BID PLAN - ELECTRICAL DEMOLITION

SCALE: 1/8"=1'-0"

ALTERNATE BID PLAN #1 — ELECTRICAL DEMOLITION

SCALE: 1/8"=1'-0"



KEYPLAN

MARK	DATE	DESCRIPTION
Δ	7/21/08	
DATE:		06-30-200

DATE: 06-30-2008

PROJECT NO: 0763.01

CAD DWG FILE NO: DRAWN BY: CHECKED BY: DESIGNED BY:

DWG TYPE:

ARCHITECTURAL PHASE:


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BASE BID
AND ALTERNATE
PLANS
- ELECTRICAL
DEMOLITION

ED-101

EELD #210 SHEET

2 OF 4

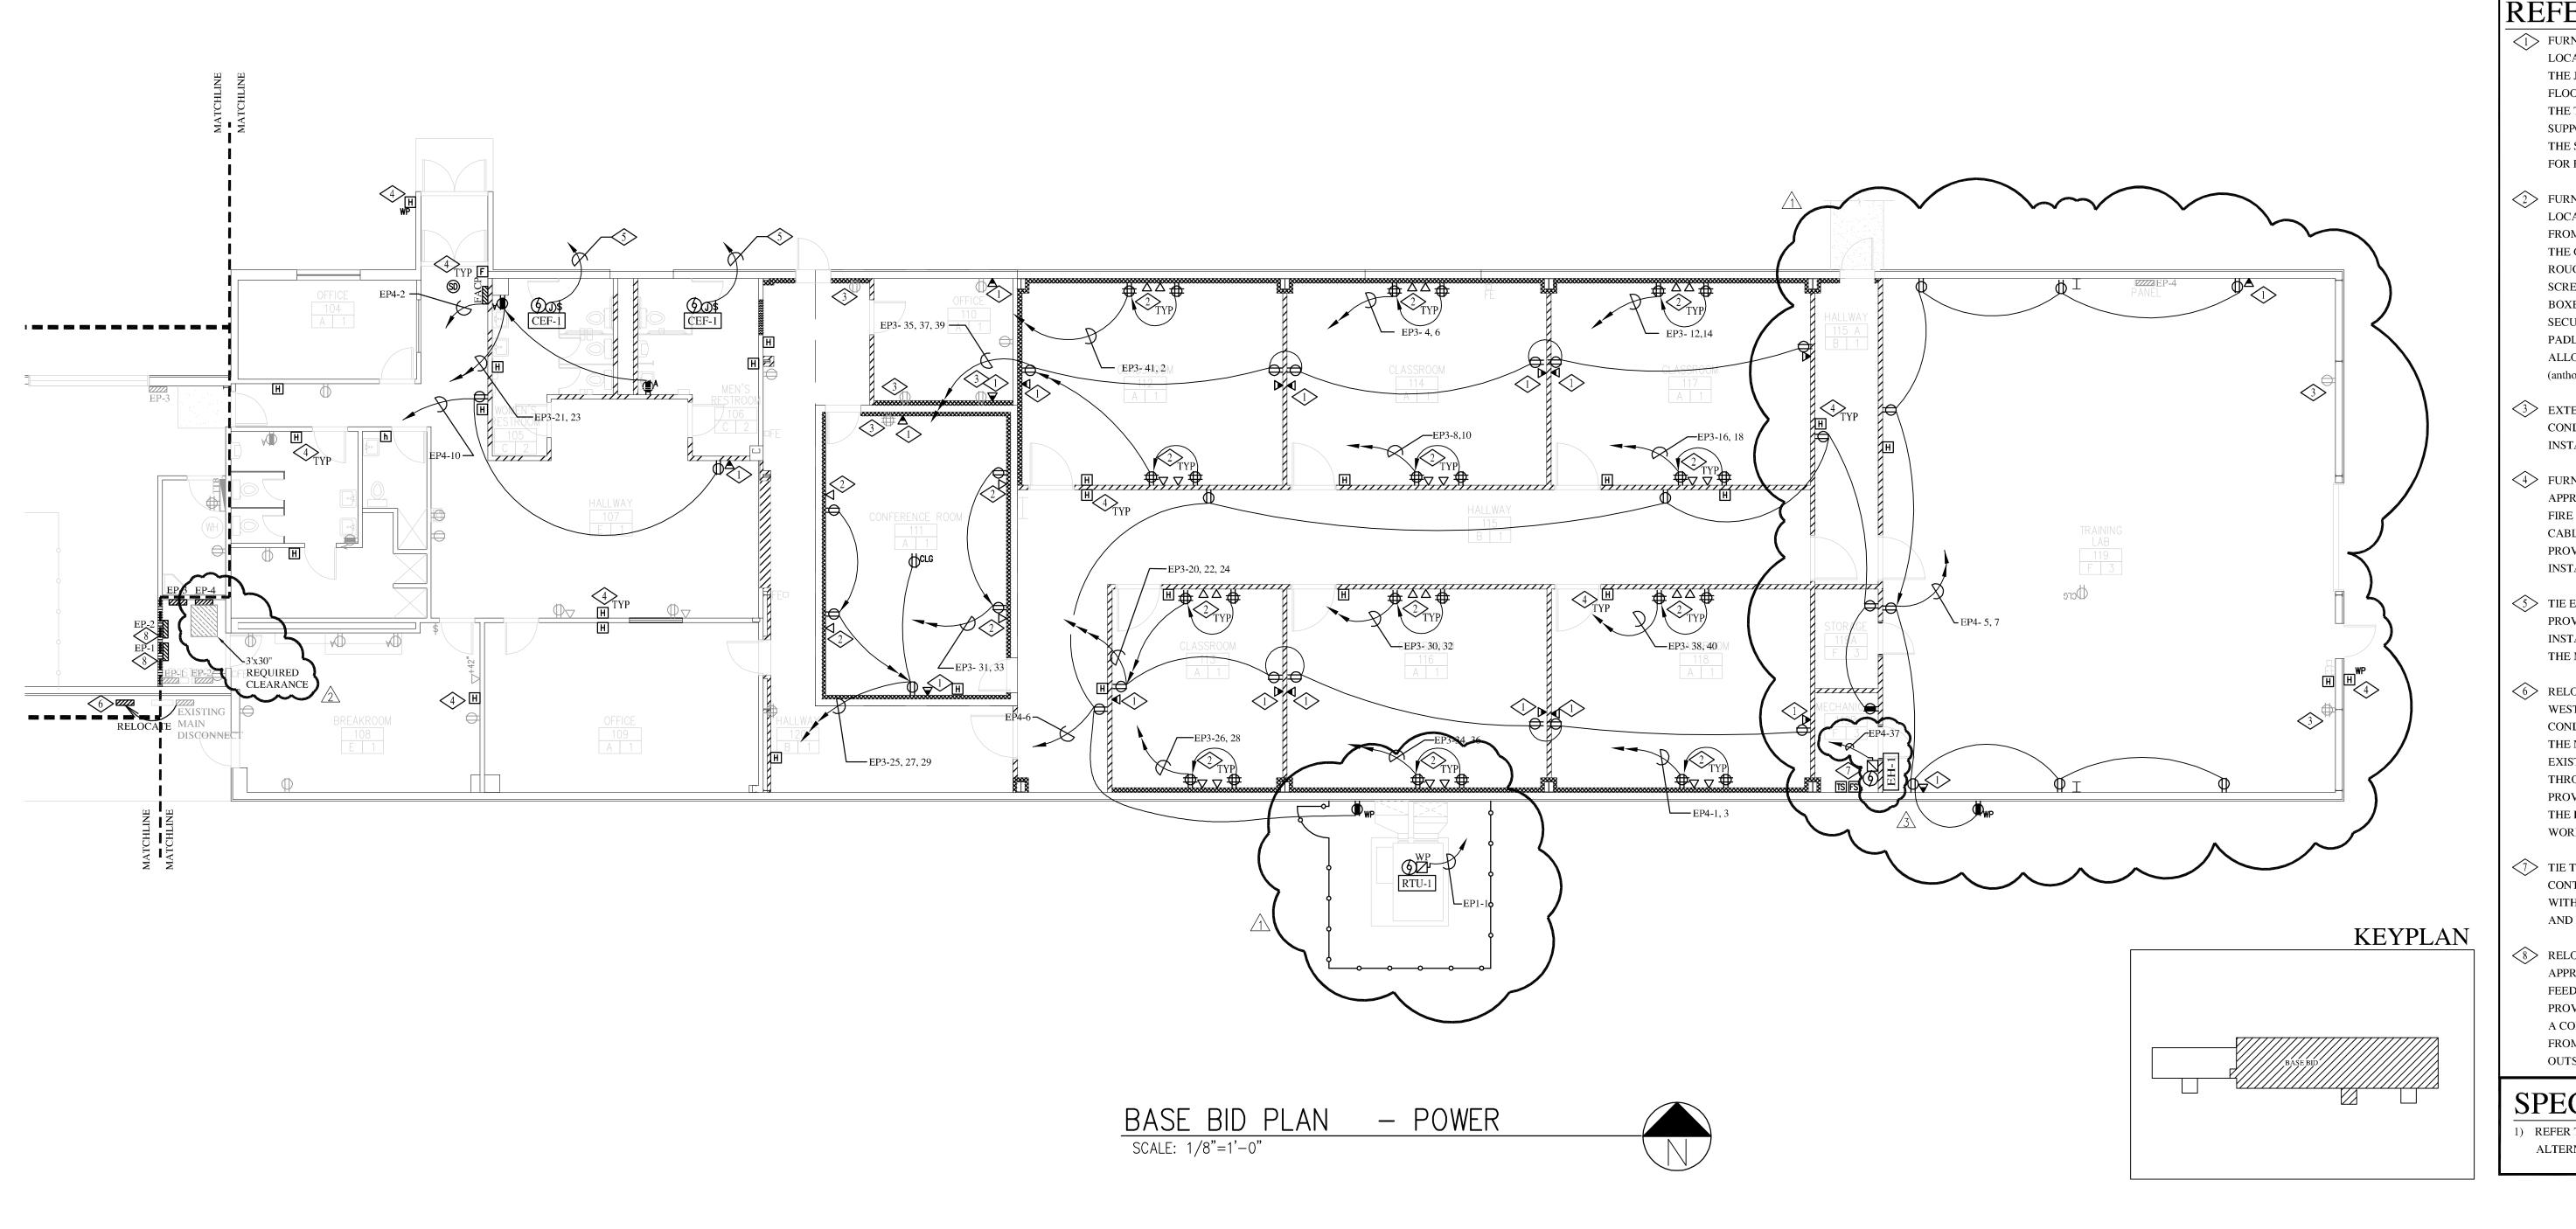


REFERENCE NOTES: POWER

- FURNISH AND INSTALL A 4"X4"X2-1/8" J-BOX IN THE APPROXIMATE LOCATION SHOWN FOR VOICE/DATA. RUN A 3/4" CONDUIT FROM THE J-BOX TO THE NEAREST ACCESSIBLE CEILING SPACE ON THIS FLOOR. RUN ONE VOICE AND ONE DATA CABLE FROM J-BOX TO THE TTB. SEE SPECIFICATIONS FOR MORE INFORMATION. SUPPORT AND ORGANIZE CABLES USING J-HOOKS ATTACHED TO THE STRUCTURE. COORDINATE WITH THE OWNER/ARCHITECT FOR EXACT LOCATION PRIOR TO ROUGH-IN.
- FURNISH AND INSTALL A 4"X4"X2-1/8" J-BOX IN THE APPROXIMATE LOCATION SHOWN FOR SECURED DATA. RUN A 1" EMT CONDUIT FROM THE J-BOX TO THE ELECTRICAL ROOM. COORDINATE WITH THE OWNER/ARCHITECT FOR EXACT LOCATION PRIOR TO ROUGH-IN. UTILIZE COMPRESSION FITTING CONNECTORS. SET SCREW TYPE FITTINGS ARE NOT ALLOWED. COVERS FOR PULL BOXES SHALL NOT CONTAIN REMOVABLE HINGE PINS AND BE SECURED WITH A GSA APPROVED CHANGEABLE COMBINATION PADLOCK. BOXES WITH PRE-PUNCHED KNOCKOUTS ARE NOT ALLOWED. COORDINATE THIS WORK WITH THE ANTONY BERGE (anthony.berge@us.army.mil).
- EXTEND CIRCUITS AND DEVICES TO NEW WALL. PROVIDE CONDUIT, CONDUCTORS, ETC. AS NECESSARY FOR A COMPLETE INSTALLATION.
- FURNISH AND INSTALL NEW FIRE ALARM DEVICES IN THE APPROXIMATE LOCATIONS SHOWN. TIE THE NEW DEVICES TO THE FIRE ALARM CONTROL PANEL. UTILIZE CLASS "A" LOOP. RUN ALL CABLES IN CONDUIT. REFER TO FIRE ALARM RISER DIAGRAM. PROVIDE CONDUITS, CONDUCTORS, RELAY, ETC., FOR A COMPLETE INSTALLATION.
- TIE EXHAUST FAN TO THE LIGHTING CIRCUIT IN THE ROOM.
 PROVIDE CONDUIT, CONDUCTORS, ETC. FOR A COMPLETE
 INSTALLATION. THE EXHAUST FAN SHALL BE CONTROLLED BY
 THE MOTION SENOR.
- RELOCATE EXISTING EXTERIOR MAIN DISCONNECT 4' TO THE WEST TO THE APPROXIMATE LOCATION SHOWN. RUN NEW CONDUCTORS AND CONDUITS FROM THE DISCONNECT SWITCH TO THE NEW LOCATION OF PANEL "EP-1". PROPERLY COVER THE EXISTING PENETRATION HOLE. FIELD VERIFY. CUT OR PUNCH THROUGH TERRANCE ROOF AS NEEDED FOR OVERHEAD SERVICE. PROVIDE ADDITIONAL CONDUCTORS FROM THE TRANSFORMER TO THE DISCONNECT SWITCH AS NECESSARY. COORDINATE THIS WORK WITH THE OWNER/ARCHITECT.
- TIE TAMPER SWITCH AND FLOW SWITCH TO THE FIRE ALARM CONTROL PANEL. PROVIDE MONITORING MODULE. COORDINATE WITH THE SUB CONTRACTOR FOR EXACT LOCATION OF TAMPER AND FLOW SWITCHES PRIOR TO ROUGH-IN.
- RELOCATE EXISTING PANEL "EP-1" AND PANEL "EP-2" TO THE APPROXIMATE LOCATION SHOWN. EXTEND ALL EXISTING FEEDERS AND BRANCH CIRCUITS TO THE NEW LOCATIONS SHOWN. PROVIDE PROPER SPLICE BOX, CONDUIT, CONDUCTORS, ETC. FOR A COMPLETE INSTALLATION. FIELD VERIFY. FEED PANEL "EP-1" FROM THE NEW LOCATION OF 600AMP DISCONNECT SWITCH OUTSIDE.

SPECIAL NOTES:

1) REFER TO ARCHITECTURAL DRAWINGS FOR BASE BID AND ALTERNATE BID.

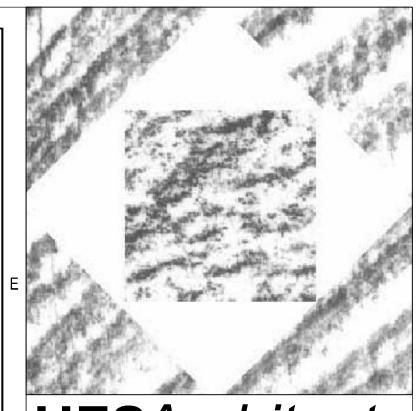

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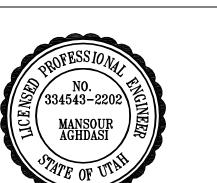
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CHOCK WATCHINE WATCHINE	HALWAY 15 A 1 1
ALTERNATE BID 91	HALWAY 115 B 1 1 TRANNG LAB STORAGE B 1 1 STORAGE 119 A 1 1 ECHANICA 119 B 1
ALTERNATE BID PLAN #1 — POWER SCALE: 1/8"=1'-0"	ALTERNATE BID PLAN #2 — POWER SCALE: 1/8"=1'-0"

MARK	DATE	DESCRIPTION	
\triangle	7/21/08	PLAN REVIEW	
2	8/11/08	PLAN REVIEW	
3	8/11/08	MECH. UPDATE	
DATE:			06-30-2008
PR	OJECT NO:		

PROJECT NO:

HFSA PROJECT NO:

CAD DWG FILE NO:

DRAWN BY:

CHECKED BY:

DESIGNED BY:

DWG TYPE:

DWG TYPE:

ARCHITECTURAL PHASE:


SHEET TITLE

ALTERNATE FLOOR
PLANS AND BASE
BID
- POWER

EP-101

EELD #210 SHEET

EET 3 OF 4

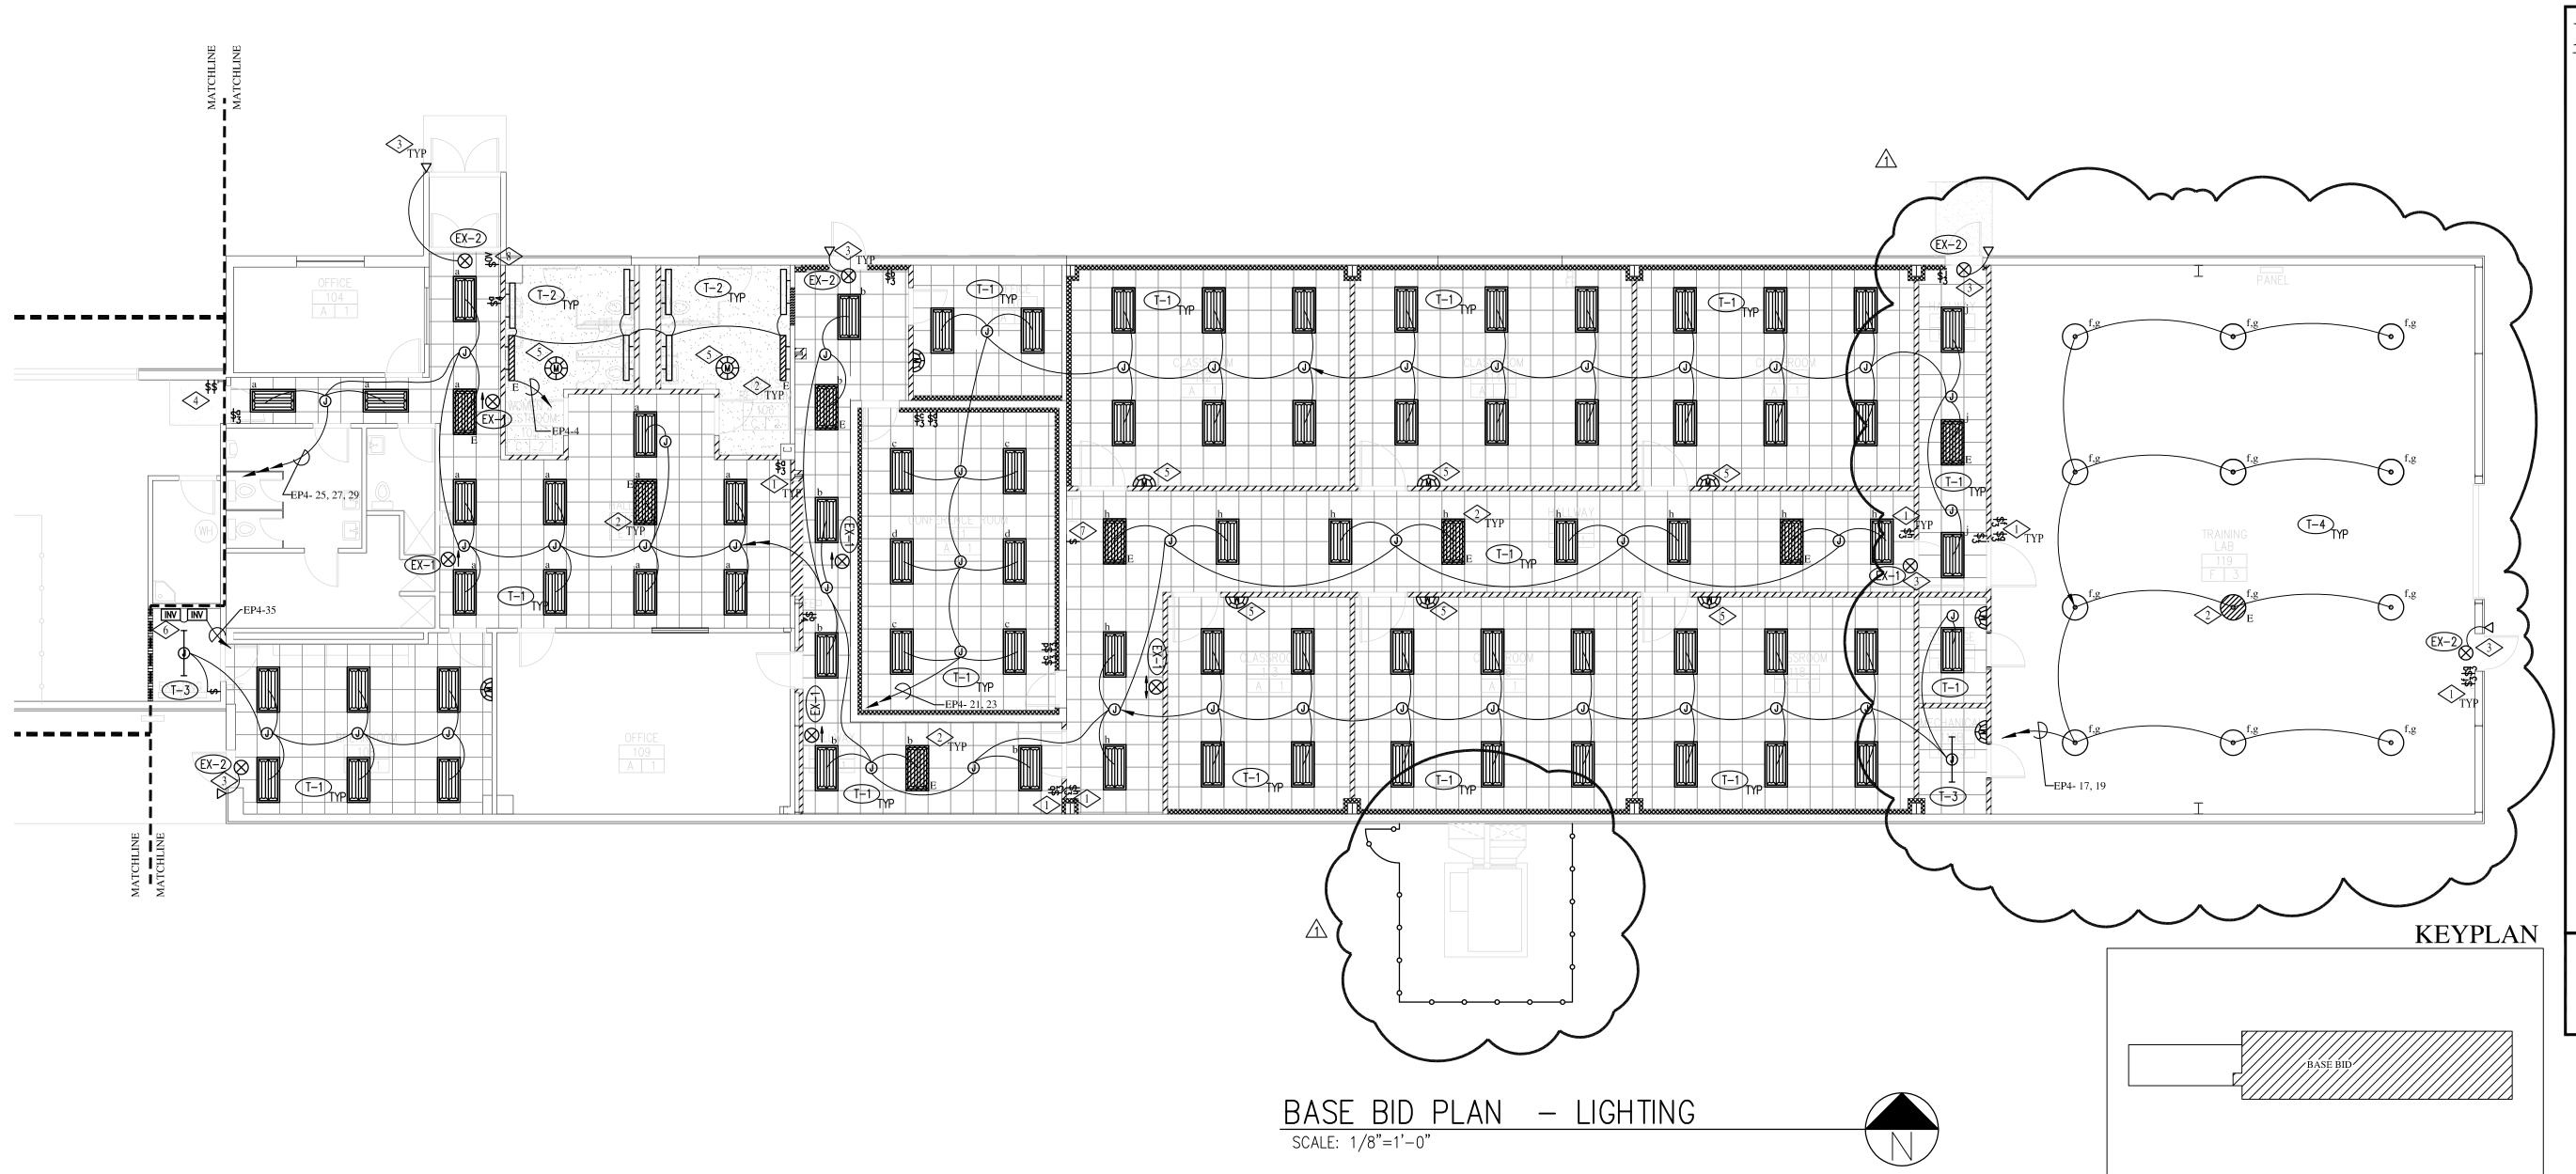


REFERENCE NOTES: LIGHTING

- TIE ALL FIXTURES INDICATED WITH A LOWER CASE LETTER TO ITS CORRESPONDING SWITCH(ES). PROVIDE CONDUITS, CONDUCTORS, LIGHTING CONTACTORS, ETC. FOR A COMPLETE INSTALLATION.
- EMERGENCY LIGHT FIXTURES INDICATED WITH THE LETTER "E" SHALL BE PROVIDED WITH A SEPARATE BALLAST FOR THE CENTER LAMP. ON LAMP IN THE LIGHT FIXTURE SHALL BE TIED TO THE EMERGENCY INVERTER AND TURN ON WHEN THE COMMERCIAL POWER FAILS REGARDLESS OF THE POSITION OF THE CONTROL SWITCH. ALL THE LAMPS IN THE FIXTURE SHALL BE CONTROLLED BY THE INDICATED SWITCH. PROVIDE CONDUITS, CONDUCTORS, ETC.. FOR A COMPLETE INSTALLATION. RUN THE EMERGENCY CIRCUIT IN A SEPARATE RACEWAY.
- ② EXIT SIGNS TO AN UNSWITCHED EMERGENCY LIGHTING CIRCUIT. PROVIDE CONDUITS, CONDUCTORS, RELAY BALLAST'S, ETC.. FOR A COMPLETE INSTALLATION.
- RELOCATE SWITCHES AND ASSOCIATED CONDUCTORS NEAR EXISTING PANEL "EP-1" TO THE APPROXIMATE LOCATION SHOWN. PROVIDE CONDUIT, CONDUCTORS, ETC. FOR A COMPLETE INSTALLATION. THIS WORK IS PART OF BASE BID. AS PART OF ALTERNATE BID, REMOVE THESE LIGHT SWITCHES
- FURNISH AND INSTALL DUAL TECHNOLOGY MOTION SENSOR TO CONTROL THE LIGHT FIXTURES IN THE ROOM. SET THE TIME DELAY FO 30 MINUTES. WATT STOPPER, LITHONIA, LEVITON, & SENSOR SWITCH ARE THE APPROVED MANUFACTURERS.
- FURNISH AND INSTALL TWO 250 WATT EMERGENCY INVERTER IN THE APPROXIMATE LOCATION TO FEED THE EMERGENCY LIGHTS. TIE THE EMERGENCY LIGHTS FIXTURE TO THE INVERTER UTILIZING SEPARATE RACE WAY THAN THE NORMAL LIGHTING CIRCUIT. CONDUIT, CONDUCTORS, RELAY, ETC., FOR A COMPLETE INSTALLATION. GUTH IS AN APPROVED MANUFACTURER.
- NEW SWITCH TO CONTROL EXISTING LIGHTS IN THE MEZZANINE.
 PROVIDE CONDUIT, CONDUCTORS, ETC. TO ACCOMMODATE NEW
 SWITCHES.
- RUN ALL THE LIGHTING CIRCUITS THROUGH LIGHTING CONTACTORS. FURNISH AND INSTALL AN OVER-RIDE SWITCH IN THE APPROXIMATE LOCATION SHOWN AND TIE TO THE LIGHTING CONTACTORS. PROVIDE CONDUITS, CONDUCTORS, ETC. FOR A COMPLETE INSTALLATION. COORDINATE WITH THE OWNER FOR THE EXACT LOCATIONS OF OVER-RIDE SWITCH.

SPECIAL NOTES:

1) REFER TO ARCHITECTURAL DRAWINGS FOR BASE BID AND ALTERNATE BID.

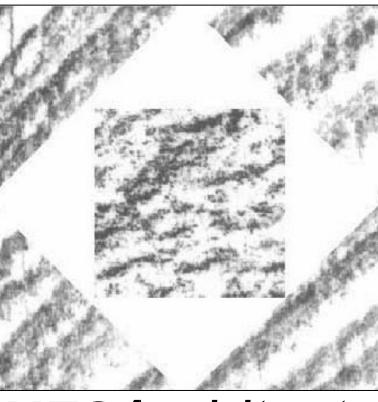

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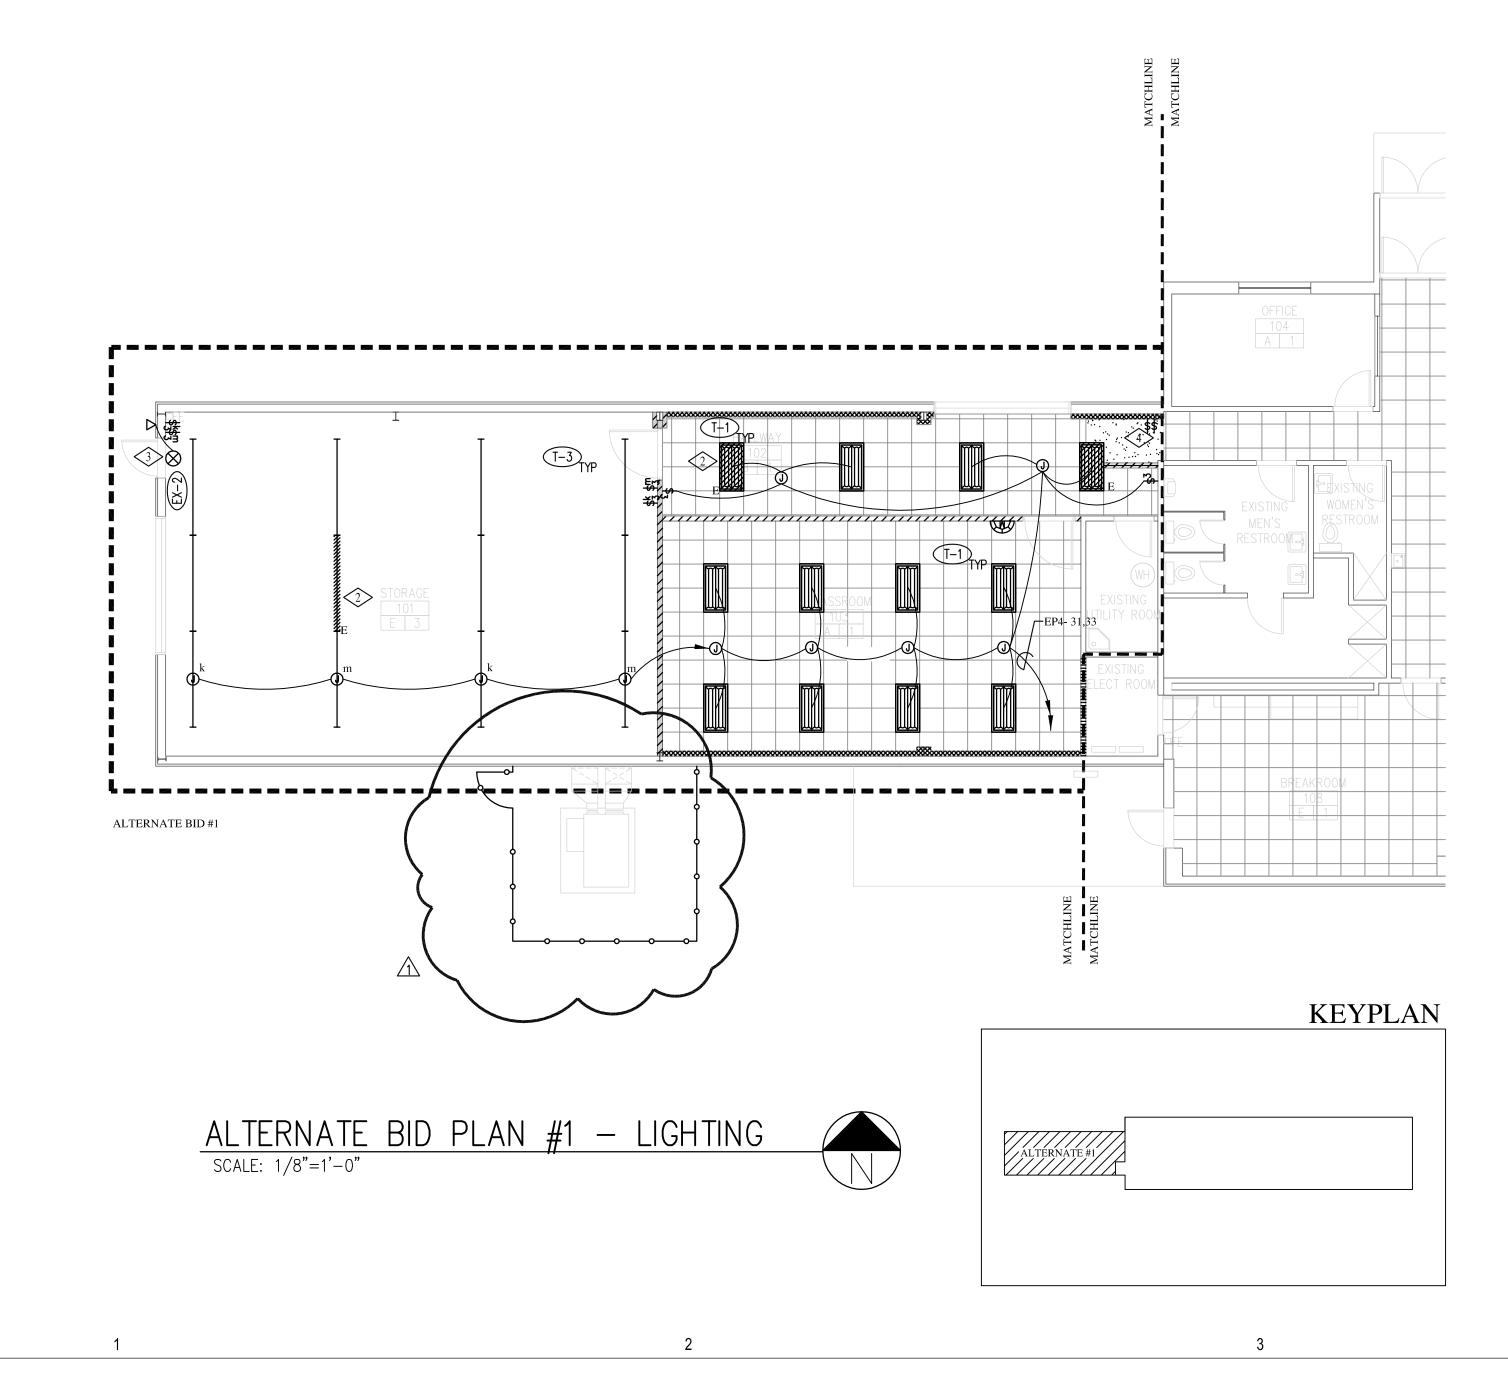
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CAMP WILLIAMS BLDG. 1830 REMODEL UTAH NATIONAL GUARD



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\triangle	7/21/08						
DATE:		06-30-2008					
PF	ROJECT NO:						
HFSA PR	OJECT NO:	0763.0 ⁻					
CAD DW	FILE NO:						
DRAWN BY:							
CHECKED BY:							
DESIGNED BY:							
DWG TYPE:							
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EL-101

PLANS AND BASE BID

- LIGHTING

EELD #210 SHEET

4 OF 4